

INTERIOR RENOVATION 1053 GILMORE LAKE RD WATERLOO, IL 62298

GRAPHIC SYMBOLS:

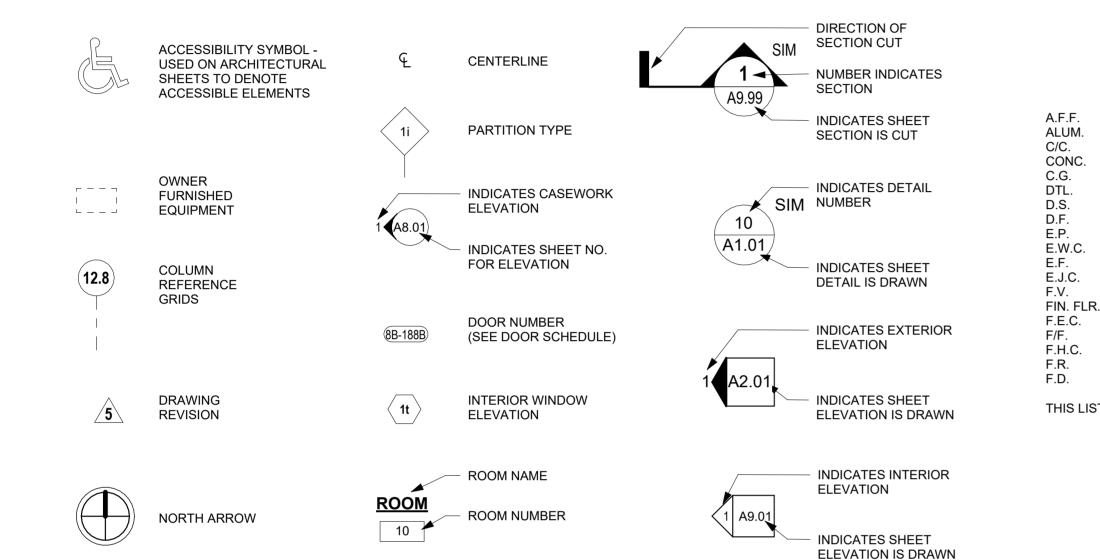

VICINITY MAP

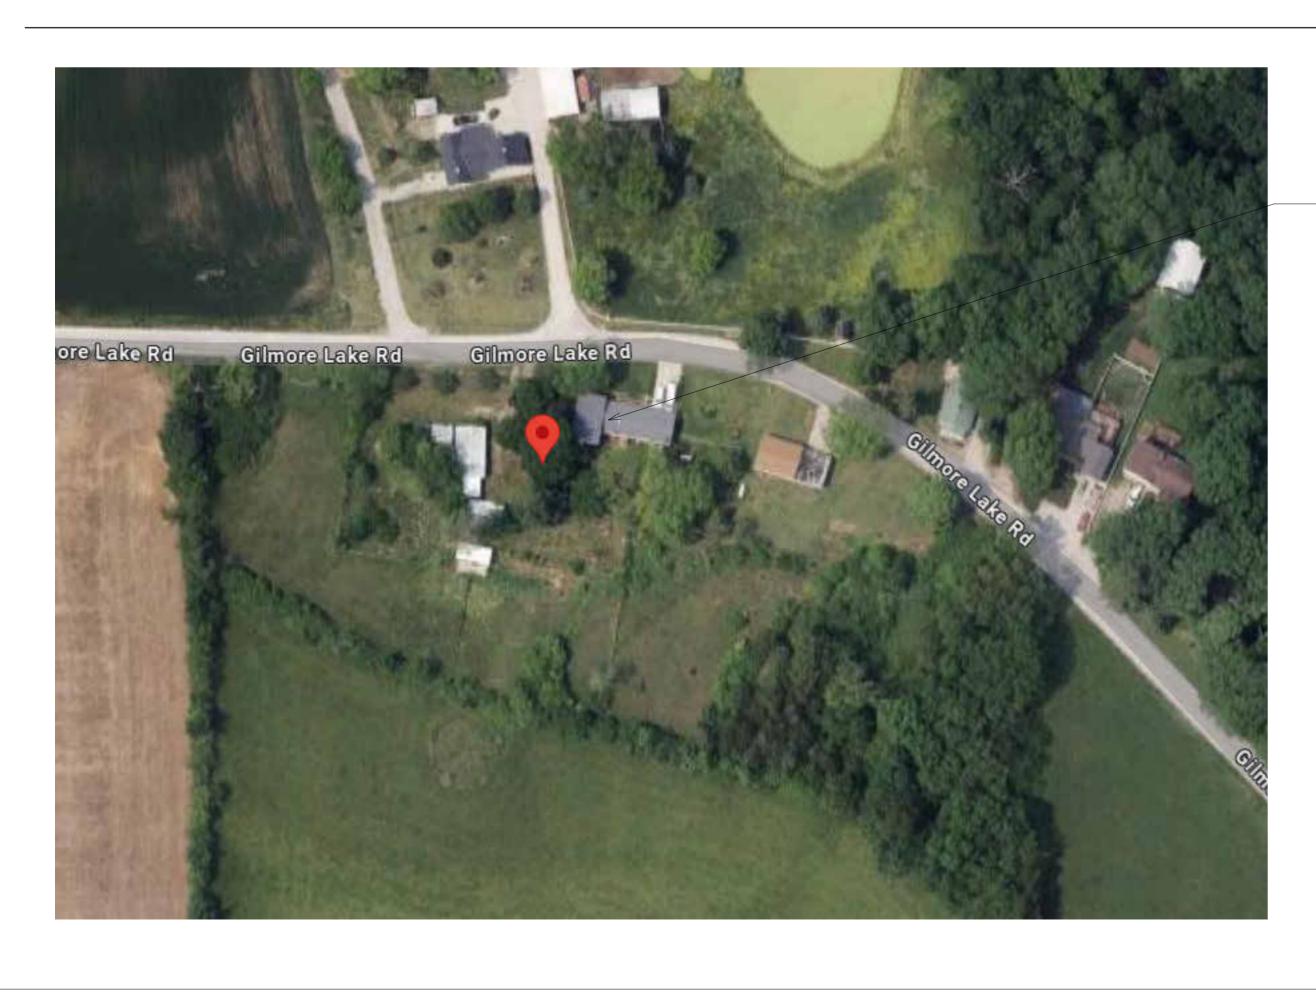

ABBREVIATIONS:

- ABOVE FINISH FLOOR
- ALUMINUM
- CENTER TO CENTER
- CONCRETE
- CORNER GUARD
- DETAIL
- DOWNSPOUT
- DRINKING FOUNTAIN
- ELECTRICAL PANEL
- ELECTRIC WATER COOLER
- EXHAUST FAN
- EXPANSION JOINT COVER
- FIELD VERIFY
- FINISHED FLOOR
- FIRE EXTINGUISHER CABINET
- FACE TO FACE
- FIRE HOSE CABINET
- FIRE RETARDANT

THIS LIST IS NOT ALL INCLUSIVE

- FLOOR DRAIN

GYP. BD. - GYPSUM BOARD H.M. - HOLLOW METAL INSUL - INSULATION N.C. - NARCOTICS CABINET N.I.C. - NOT IN CONTRACT N.T.S. - NOT TO SCALE O.C. - ON CENTER O.F.E. - OWNER FURNISHED EQUIPMENT O.F.C.I. P.T.

G.I.

R.D.

S.B.

SIM.

TYP.

WR

U.N.O.

- OWNER FURNISHED CONTRACTOR INSTALLED - PRESSURE TREATED

- GALVANIZED IRON

- ROOF DRAIN - SPLASH BLOCK
- SIMILAR - TOP OF
- TYPICAL
- UNLESS NOTED OTHERWISE - WATER RESISTANT

PROJECT SITE: 1053 GILMORE LAKE DR. WATERLOO, IL 62298

SHEET INDEX								
SHEET NUMBER	SHEET NAME	ISSUE DATE	CURRENT REVISION	CURRENT REVISION DATE	DISCIPLINE			
	- -							
CS1.01	COVER SHEET	09/13/24			00 GEN			
D1.01	DEMOLITION PLAN + NOTES	09/13/24			00 GEN			
A1.01	FLOOR PLANS	09/13/24			03 ARCH			
A1.02	FRAMING PLANS	09/13/24			03 ARCH			
A3.01	SCHEDULES + DETAILS	09/13/24			03 ARCH			
A6.01	REFLECTED CEILING + ELECTRICAL PLANS	09/13/24			03 ARCH			

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A6.01	REFLECTED CEILING + ELECTRICAL PLANS	09/13/24			03 ARCH		

GENERAL NOTES:

GENERAL:

- HARDWARE, ETC. WHETHER IMPLIED OR EXPLICITLY CALLED OUT ON DRAWINGS.
- JOB SITE SAFETY IS THE SOLE RESPONSIBILITY OF THE CONTRACTOR.
- DETAIL.

- CHARGE.
- ALL REQUESTS, CHANGES OR QUESTIONS TO THE ARCHITECT.
- MAKE APPROPRIATE DECISIONS OR ANY NECESSARY ADJUSTMENTS.
- 10
- 11.
- 12.
- 13.
- 14.
- 15. PROCEEDING.
- 16. FLUSH, STRAIGHT, AND WELL-SECURED CONDITIONS.
- 18. 19.
- 20
- THE VARIOUS CONTRACTORS AND SUBCONTRACTORS INVOLVED. 21.
- 22.
- 23.
- 24. UNLESS NOTED OTHERWISE.
- PRINTERS, FAX MACHINES, ETC.
- 26. GENERAL CONTRACTOR TO PROVIDE BLACK BACKGROUND ADA SIGNAGE AS REQUIRED BY CODE.
- 27. TO OWNER.
- 28 WALLS WITH U.L. LISTED FIRE ASSEMBLIES.
- THE DRYWALL SYSTEM IS BASED ON DETAILS OF THE U.S. GYPSUM COMPANY. 29.
- 30.
- 31. 32
- REQUIREMENTS. CONCRETE:
- APPROVED TERMITE TREATMENT.
- 3
- SLAB THICKNESS, U.N.O.
- 5
- STEEL REINFORCING SHALL HAVE A MINIMUM OF 2" CONCRETE COVER U.N.O. 7
- 8. ALL OPENINGS LARGER THAN 12' - 0", U.N.O.

THIS DOCUMENT IS PROVIDED FOR BASIC CONSTRUCTION PURPOSES ONLY. THE ARCHITECT DOES NOT WARRANT ANY MATERIAL, EQUIPMENT

ALL GENERAL NOTES APPLY TO THE SCOPE OF THIS TOTAL PROJECT, REGARDLESS OF WHETHER OR NOT THEY ARE KEYED ON EVERY SHEET TO A SPECIFIC

THE GENERAL CONTRACTOR SHALL ENSURE THAT ALL CONSTRUCTION MEETS OR EXCEEDS APPLICABLE CODES AND STANDARD PRACTICES, INCLUDING ALL FEDERAL, STATE, AND LOCAL BUILDING AND ACCESSIBILITY REQUIREMENTS AND REGULATIONS EXCEPT WHERE THESE DOCUMENTS CLEARLY INDICATE THAT PARTICULAR CODES ISSUES HAVE BEEN CONSIDERED AND ADDRESSED. THE CONTRACTOR SHALL BE RESPONSIBLE FOR ANY VIOLATIONS NOT SPECIFICALLY ADDRESSED BY THESE DOCUMENTS AND SHALL MAKE ALL WORK ACCEPTABLE TO THE PUBLIC DEPARTMENT INVOLVED WITHOUT EXTRA CHARGE

THE CONTRACTOR SHALL VERIFY DIMENSIONS AND SITE CONDITIONS BEFORE STARTING WORK. THE ARCHITECT SHALL BE NOTIFIED OF ANY DISCREPANCY CONTRACTOR SHALL INCLUDE, AT NO ADDITIONAL COST TO THE OWNER, WORK REQUIRED BY EXISTING CONDITIONS THAT MAY NOT BE NOTED IN THESE DOCUMENTS BUT THAT IS REQUIRED TO COMPLETE THE SCOPE OF WORK SHOWN IN THESE DOCUMENTS UNLESS SUCH CONDITIONS ARE CONCEALED AND COULD NOT BE DETERMINED THROUGH A THOROUGH INVESTIGATION OF THE EXISTING CONDITIONS.

ALL ITEMS DEPICTED GRAPHICALLY, WHETHER NOTED OR NOT, ARE PART OF THE CONTRACTOR 'S SCOPE OF WORK AND SHALL BE PROVIDED AT NO EXTRA

ALL PERMITS (OCCUPANCY, ELECTRICAL, PLUMBING, AND ALL OTHERS) REQUIRED BY STATE AND LOCAL CODES, EXCEPT THOSE ACQUIRED BY SUBCONTRACTORS, ARE TO BE SECURED BY THE GENERAL CONTRACTOR. PROVIDE COPIES TO THE ARCHITECT WITHOUT EXTRA CHARGE. ALL PERMITS ACQUIRED BY SUBCONTRACTORS SHALL BE SUBMITTED TO THE GENERAL CONTRACTOR FOR RECORD.

EACH TRADE SHALL VERIFY ALL REQUIREMENTS PERTAINING TO WORK PERFORMED IN THE PROJECT AND OBTAIN ANY REQUIRED PERMITS. ALL SUBCONTRACTORS SHALL DIRECT QUESTIONS, CHANGES OR REQUESTS THROUGH THE GENERAL CONTRACTOR. THE GENERAL CONTRACTOR SHALL SUBMIT

THE GENERAL CONTRACTOR SHALL CONFIRM THAT THE LAYOUT OF THE SPACE CAN BE ACCOMPLISHED AS DESIGNED. THE ARCHITECT MUST BE NOTIFIED OF ANY PROBLEMS WITH PROPOSED WALL LOCATIONS AFTER THE CHALK LINES ARE IN PLACE AND BEFORE THE FLOOR PLATES ARE FASTENED IN ORDER TO

IF UNANTICIPATED MECHANICAL, PLUMBING, ELECTRICAL, OR STRUCTURAL ELEMENTS OR ANY OTHER CONDITIONS ARE ENCOUNTERED WHICH MIGHT CONFLICT WITH THE INTENDED FUNCTION, CONTACT THE ARCHITECT IMMEDIATELY FOR CLARIFICATION.

THE CONTRACTOR SHALL PROMPTLY REMEDY ANY DAMAGE AND/OR LOSS TO PROPERTY (ALL MATERIALS AND EQUIPMENT INCORPORATED INTO THE WORK DESCRIBED HEREIN) CAUSED IN WHOLE OR IN PART BY THE CONTRACTOR, A SUBCONTRACTOR, OR ANYONE DIRECTLY OR INDIRECTLY EMPLOYED BY ANY OF THEM. NO BUILDING MATERIALS CONTAINING ASBESTOS OR OTHER HAZARDOUS MATERIALS SHALL BE INSTALLED ON THIS PROJECT

FIRE-RATED PARTITIONS SHALL BE IDENTIFIED AS SUCH IN LARGE RED STENCIL ABOVE CEILINGS.

THE GENERAL CONTRACTOR SHALL MAINTAIN ALL RATING OF ALL REQUIRED RATED WALLS AT ALL INTERSECTIONS, CONNECTIONS, AND PENETRATIONS. ALL INTERIOR DIMENSIONS ARE TO FACE OF STUDS UNLESS NOTED OTHERWISE. EXTERIOR DIMENSIONS ARE TO OUTSIDE FACE OF WALLS. DO NOT SCALE DRAWINGS. IF DIMENSIONS ARE IN QUESTION, THE CONTRACTOR SHALL BE RESONSIBLE FOR OBTAINING CLARIFICATION FROM THE ARCHITECT BEFORE

PROVIDE WOOD BLOCKING (FIRE RETARDANT WHERE REQUIRED BY CODE) INSIDE PARTITIONS FOR SECURING WALL-HUNG CABINETS, SHELVING, TRIM, MILLWORK AND OTHER ELEMENTS ATTACHED TO PARTITIONS, WHETHER OWNER FURNISHED AND INSTALLED OR CONTRACTOR FURNISHED AND INSTALLED, TO ENSURE

17. COMPLY WITH ALL APPLICABLE ACCESSIBILITY CODES WHEN INSTALLING AND FRAMING OPENINGS FOR DOORS.

MATERIALS PROVIDED SHALL BE INSTALLED PER MANUFACTURER'S WRITTEN RECOMMENDATIONS AND PER CODE REQUIREMENTS.

ITEMS REQUIRING FINISH SELECTIONS THAT DO NOT APPEAR IN THE CONSTRUCTION DOCUMENTS SHALL BE SELECTED FROM SHOP DRAWING SUBMITTALS. THE CONTRACTOR SHALL COORDINATE THE ARCHITECTURAL, CIVIL, STRUCTURAL, MECHANICAL, ELECTRICAL, AND PLUMBING CONSTRUCTION DOCUMENTS WITH

ALL PIPING ABOVE GRADE AND INSIDE THE BUILDING SHOWN ON THESE DRAWINGS SHALL BE INSTALLED IN AREAS WHERE IT WILL BE CONCEALED. THE CONTRACTOR SHALL COORDINATE WITH OTHER TRADES TO PROVIDE FURRING FOR PIPING INSTALLED IN FINISH AREAS.

FOR ELECTRICAL BOXES INSTALLED ON OPPOSITE SIDES OF WALLS, PROVIDE A MINIMUM HORIZONTAL SEPARATION OF ONE STUD SPACING.

GROUPS OF RECEPTACLES SHALL BE MOUNTED WITH A 1 ½" MINIMUM DISTANCE BETWEEN FACE PLATES.

WHEN GRAPHICALLY DEPICTED IN SIMILAR LOCATIONS, ALIGN OUTLETS, THERMOSTATS, AND OR FIRE PROTECTION DEVICES VERTICALLY. OUTLETS GRAPHICALLY DEPICTED TO BE CENTERED IN A PARTICULAR WALL SHOULD BE MEASURED IN THE FIELD AND LOCATED IN THE CENTER OF THE WALL

CONTRACTOR TO VERIFY AND PROVIDE ALL ELECTRICAL REQUIREMENTS FOR ALL OWNER FURNISHED, OWNER INSTALLED AND CONTRACTOR FURNISHED, CONTRACTOR INSTALLED EQUIPMENT AND APPLIANCES, INCLUDING BUT NOT LIMITED TO COFFEE MAKERS, MICROWAVES, REFRIGERATOR, COPIERS,

ALL SIGNAGE, EXCLUDING TEMPORARY ADA SIGNAGE, TO BE PROVIDE BY OWNER AND INSTALLED BY CONTRACTOR UNLESS NOTED OTHERWISE.

SLOPE ALL HORIZONTAL SURFACES TO DRAIN SUCH THAT THERE WILL BE NO PONDING OF WATER. CORRECT AREAS OF PONDING AT NO ADDITIONAL COST

IN AREAS IN WHICH WORK IS DONE, SEAL ALL WALL PENETRATIONS EXISTING AND NEW TO MAINTAIN THE INTEGRITY OF THE EXISTING WALLS AND NEW

ALL GYPSUM BOARD ABUTTING OTHER MATERIALS IS TO BE FINISHED WITH METAL EDGES OR FIRE-STOPPED AS REQUIRED.

WATER RESISTANT GYPSUM BOARD IS TO BE USED BEHIND ALL PLUMBING FIXTURES & CERAMIC TILE AND OTHER WET AREAS.

DIMENSIONS ARE TO BE COORDINATED WITH ALL DISCIPLINES, VENDORS, O.F.E. AND DEVICES TO ASSURE PROPER PLACEMENT AND WARRANTY

ALL FOOTINGS SHALL BEAR ON UNDISTURBED SOIL OR ENGINEERED FILL (2000 psf MIN. SOIL BEARING CAPACITY) AND BE A MIN. OF 2' - 8" BELOW GRADE. BASEMENT SLAB SHALL BE 4" REINFORCED 3,000 psi CONCRETE INSTALLED OVER 6-MIL VAPOR BARRIER AND 4" MIN. COMPACTED GRANULAR FILL WITH

BASEMENT WALLS AND FLOORS SHALL BE TREATED TO PROVIDE RESISTANCE TO THE INFILTRATION OF WATER AND PROPERLY REINFORCED TO WITHSTAND HYDROSTATIC PRESSURE AS NECESSARY. ALL JOINTS IN WALLS AND FLOORS TO BE CAULED AND MADE WATERTIGHT. SLABS ON GRADE SHALL BE 4" 3,000psi CONCRETE WITH 1 1/2 lb/cy POLYPROPYLENE FIBERS, OR 6x6 #10/10 WWM REINFORCEMENT PLACED IN CENTER OF

SLAB FINISHES: EXTERIOR WALKING SURFACES - MEDIUM BROOM; DRIVING SURFACES - MEDIUM BROOM; INTERIOR SURFACES - STEEL TROWEL. PLACE CRACK CONTROL JOINTS AT 12' - 0" MAX. U.N.O. UNINTERRUPTED CONCRETE SLAB-ON-GRADE AREAS SHOULD NOT EXCEED 144 sq ft MAX OR A 2-TO-1 WIDTH-TO-LENGTH RATIO. CONTRACTOR SHOULD SUBMIT A CONTROL JOINT LAYOUT FOR ARCHITECT'S REVIEW PRIOR TO CONCRETE POUR.


SLEEVE ALL PIPES THROUGH SLABS INDIVIDUALLY. WHERE PIPES OR DUCTS PENETRATE SLAB, (2) BARS E/W MAX. MAY BE CUT. PROVIDE SPLICE BARS ALONGSIDE OPENING WITH EQUIVALENT AREA TO THE CUT BARS. WITH 36-dia BAR LAP. PLACE ALL OPENINGS LARGER THAN 6" NOT SHOWN ON STRUCTURAL DRAWINGS AND ALL CONDUITS IN SLABS IN ACCORDANCE WITH IRC. PROVIDE (1) #5 x 6' - 0" E/W PLACED DIAGONALLY AT MID-DEPTH AROUND


ALL VOIDS UNDER BASEMENT, GARAGE, EXTERIOR PORCH OR STAIR SLABS TO BE FILLED WITH CLEAN, COMPACTED GRANULAR FILL.

	262 63139 g.com 640
INTERIOR RENOVATION	1053 Gilmore Lake Rd. Waterloo, IL 62298
ISSUED DESCRIPTION - PERMIT SET - - - - - - - - - - - - -	DATE 09/13/24
REVISON REVNUMBER DESCRIPTION	DATE
DISCLAIMER: THIS DRAWING AND ASSOCIATED DOCUMEN PROPERTY OF SALAMEH & LOGAN, DRAFTI NOT TO BE REPRODUCED OR COPIED IN WHA AS REQUIRED FOR THE STATED PROJECT USED FOR THIS PROJECT AND SITE SPECIFIC AND ARE NOT TO BE USED ON ANY OTHE WRITTEN CONSENT OF SALAMEH & LOGAN, I SCALES AS NOTED ON THIS DRAWING ARE DRAWING ONLY, THE DIMENSIONS OF WHICH SHEET NAME: COVVERS SITE	NG & DESIGN, AND ARE DUE OR IN PART, EXCEPT THEY ARE ONLY TO BE JALLY IDENTIFIED HEREIN R PROJECT WITHOUT PRAFTING & DESIGN LLC. VALID ON THE ORIGINAL CH ARE 24 x 36 INCHES.
JOB NUMBER: 220	

DEMOLITION NOTES


- PRIOR TO SUBMITTING BID, CONTRACTOR SHALL FIELD VERIFY ACTUAL SCOPE OF DEMOLITION NECESSARY TO ACHIEVE RENOVATION AS DESIGNED.
- CONTRACTOR SHALL COORDINATE ALL PHASES OF DEMOLITION WITH ARCHITECT AND OWNER 2 PRIOR TO START OF WORK.
- CONTRACTOR SHALL NOTIFY ARCHITECT OF ANY EXISTING CONDITIONS IN QUESTION TO 3. DETERMINE WHETHER OR NOT THEY SHALL REMAIN.
- ALL WORK SHALL BE DONE IN ACCORDANCE WITH THE OWNER'S REQUIREMENTS AND STANDARD OPERATING PROCEDURES FOR DEMOLITION AND NEW CONSTRUCTION ACTIVITIES. THE CONTRACTOR IS RESPONSIBLE FOR COORDINATING THESE REQUIREMENTS WITH THE OWNER PRIOR TO BEGINNING WORK.
- THE CONTRACTOR SHALL COORDINATE WITH LOCAL CODE OFFICIALS TO ENSURE THAT DEMOLITION OPERATIONS ARE CONDUCTED IN COMPLIANCE WITH ALL APPLICABLE CODES.
- MAINTAIN STRUCTURAL INTEGRITY OF BUILDING. DEMOLISH AND REMOVE EXISTING 6. CONSTRUCTION ONLY TO THE EXTENT REQUIRED TO COMPLETE NEW CONSTRUCTION. USE METHODS REQUIRED TO COMPLETE WORK WITHIN LIMITATIONS OF GOVERNING REGULATIONS AND AS FOLLOWS:
- NEATLY CUT OPENINGS AND HOLES PLUMB, SQUARE AND TRUE TO DIMENSIONS REQUIRED, USE Α. CUTTING METHODS LEAST LIKELY TO DAMAGE CONSTRUCTION OR ADJOINING CONSTRUCTION.
- CUT OR DRILL FROM THE EXPOSED OR FINISHED SIDE INTO CONCEALED SPACES TO AVOID MARRING EXISTING FINISHED SURFACES. DO NOT USE CUTTING TORCHES UNTIL WORK AREA IS CLEARED OF FLAMMABLE MATERIALS. AT C.
- CONCEALED SPACES, VERIFY CONDITION AND CONTENTS OF HIDDEN SPACE BEFORE STARTING FLAME-CUTTING OPERATIONS. MAINTAIN ADEQUATE VENTILATION WHEN USING CUTTING TORCHES.
- REMOVE DECAYED, VERMIN-INFESTED OR OTHERWISE DANGEROUS OR UNSUITABLE MATERIALS AND PROMPTLY DISPOSE OF OFF-SITE. LOCATE DEMOLITION EQUIPMENT THROUGHOUT THE STRUCTURE AND REMOVE DEBRIS AND
- MATERIALS SO AS NOT TO IMPOSE EXCESSIVE LOADS ON SUPPORTING WALLS, FLOORS OR FRAMING RETURN ELEMENTS OF CONSTRUCTION AND SURFACES TO REMAIN TO CONDITION EXISTING G.
- BEFORE START OF DEMOLITION. LIMIT USE OF THE PREMISES TO CONSTRUCTION ACTIVITIES IN AREAS INDICATED AS 'SCOPE OF 7
- PROJECT. ALLOW OWNER OCCUPANCY AND USE BY OWNERS AND OWNER'S AGENTS AT ALL TIMES. ALL DRIVEWAYS AND CIRCULATION PATHS SHALL REMAIN OPEN AND AVAILABLE TO THE BUILDING 8.
- OWNER.
- WHEN UNANTICIPATED MECHANICAL, ELECTRICAL, OR STRUCTURAL ELEMENTS THAT CONFICT WITH THE INTENDED FUNCTION OR DESIGN ARE ENCOUNTERED, INVESTIGATE AND MEASURE THE NATURE AND EXTENT OF THE CONFLICT. SUBMIT A WRITTEN REPORT TO THE ARCHITECT AND OWNER BEFORE PROCEEDING.
- 10. IT IS NOT EXPECTED THAT HAZARDOUS MATERIALS WILL BE ENCOUNTERED IN THE WORK. IF ANY MATERIALS SUSPECTED OF CONTAINING HAZARDOUS MATERIALS ARE ENCOUNTERED, DO NOT DISTURB THE MATERIALS. IMMEDIATELY NOTIFY THE OWNER.
- PERFORM THE SURVEYS AS THE WORK PROGRESSES TO DETECT HAZARDS RESULTING FROM THE 11. SELECTIVE DEMOLITION.
- MAINTAIN EXISTING UTILITIES TO REMAIN IN SERVICE AND PROTECT THEM AGAINST DAMAGE 12. DURING DEMOLITION.
- WHERE UTILITY SERVICES ARE REQUIRED TO BE REMOVED, RELOCATED, OR ABANDONED, PROVDE 13. BYPASS CONNECTIONS TO MAINTAIN CONTINUITY OF SERVICE TO OTHER PARTS OF THE BUILDING BEFORE PROCEEDING. COORDINATE REQUESTS FOR UTILITY SHUT-DOWNS WITH THE OWNER A MINIMUM OF 48 HOURS PRIOR TO BEGINNING WORK.
- 14. CUT-OFF PIPE OR CONDUIT IN WALLS TO BE REMOVED. CAP, VALVE, OR PLUG AND SEAL THE REMAINING PORTION OF PIPE OR CONDUIT AFTER BYPASSING.
- CONDUCT DEMOLITION OPERATIONS TO PREVENT INJURY TO PEOPLE AND DAMAGE TO 15. ADJACENT STRUCTURE TO REMAIN. ENSURE SAFE PASSAGE OF PEOPLE AROUND THE DEMOLITION AREA.
- PROTECT WALLS, CEILINGS, FLOORS AND OTHER EXISTING FINISH WORK THAT ARE TO REMAIN 16. AND ARE EXPOSED DURING DEMOLITION.
- 17. ERECT AND MAINTAIN DUSTPROOF PARTITIONS AND TEMPORARY ENCLOSURES TO LIMIT DUST AND DIRT MIGRATION AND TO SEPARATE OCCUPIED AREAS FROM FUMES AND NOISE.
- 18. PROTECT EXISTING AIR HANDLING EQUIPMENT.
- PROVIDE AND MAINTAIN INTERIOR SHORING, BRACING, OR STRUCTURAL SUPPORT TO 19. PRESERVE STABILITY AND PREVENT MOVEMENT, SETTLEMENT, OR COLLAPSE OF ITEMS TO BE SELECTIVELY DEMOLISHED AND ITEMSE WHICH ARE IMMEDIATELY ADJACENT TO THOSE BEING REMOVED.
- PROMPTLY PATCH AND REPAIR HOLES AND DAMAGED SURFACES CUASED TO ADJACENT 20. CONSTRUCTION BY DEMOLITION, RESTORE EXPOSED FINISHES OF PATCHED AREAS AND EXTEND FINISH RESTORATION INTO ADJOINING CONSTRUCTION TO REMAIN IN A MANNER THAT ELIMINATES EVIDENCE OF PATCHING AND REFINISHING.
- SWEEP THE PROJECT SITE BROOM CLEAN AND CHANGE FILTERS ON AIR-HANDLING EQUIPMENT 21. UPON COMPLETION OF DEMOLITION.
- PROVIDE RECORD DRAWINGS AT PROJECT CLOSE-OUT WHICH IDENTIFY AND ACCURATELY 22. LOCATE CAPPED UTILITIES AND OTHER STRUCTURAL, ELECTRICAL OR MECHANICAL CONDITIONS.
- UPON COMPLETION OF DEMOLITION, SPACE SHOULD BE STRIPPED, CLEANED AND MADE READY 23. FOR NEW CONSTRUCTION.
- LIGHTLY POWER-WASH ALL BRICK TO BE PAINTED. USE CARE AS TO NOT DAMAGE BRICK OR 24 MORTAR JOINTS. TUCKPOINT ALL BRICK AS NEEDED.
- DO NOT CUT STRUCTURAL MEMBERS DURING DEMOLITION WITHOUT PROPER SHORING. PERFORM 25. ALL DEMOLITION ACCORDING TO LOCAL BUILDING CODES.

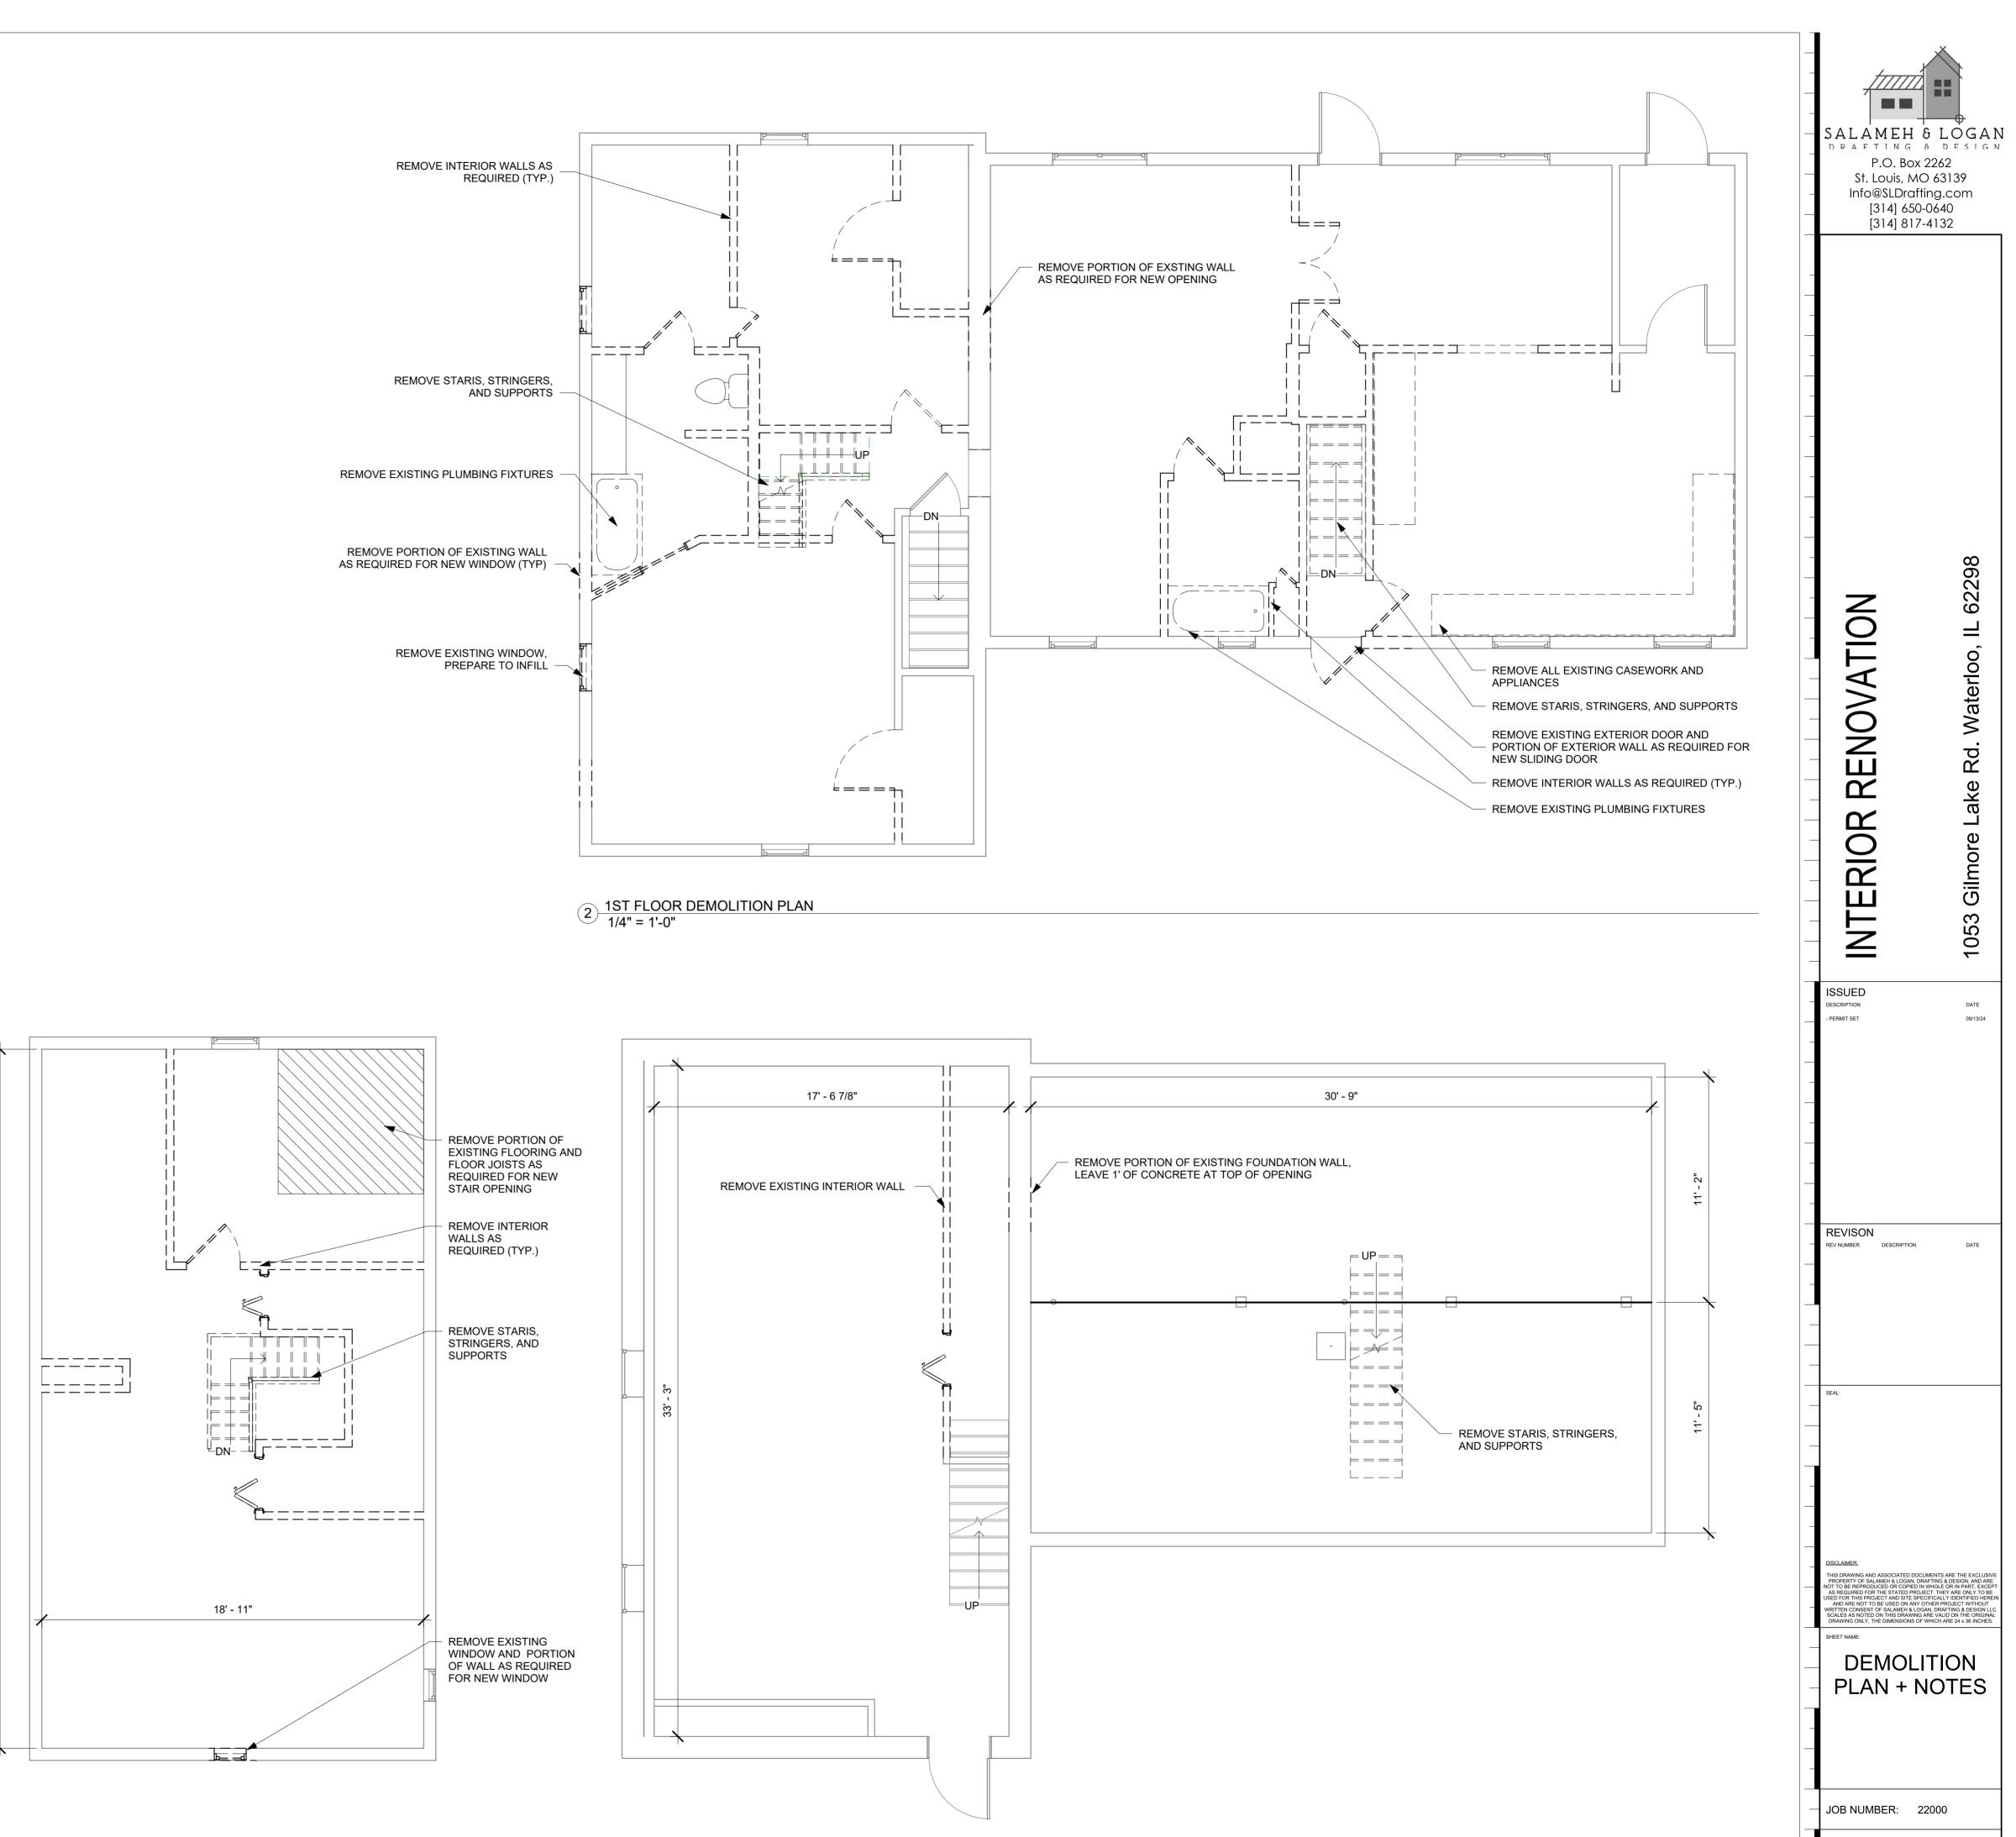


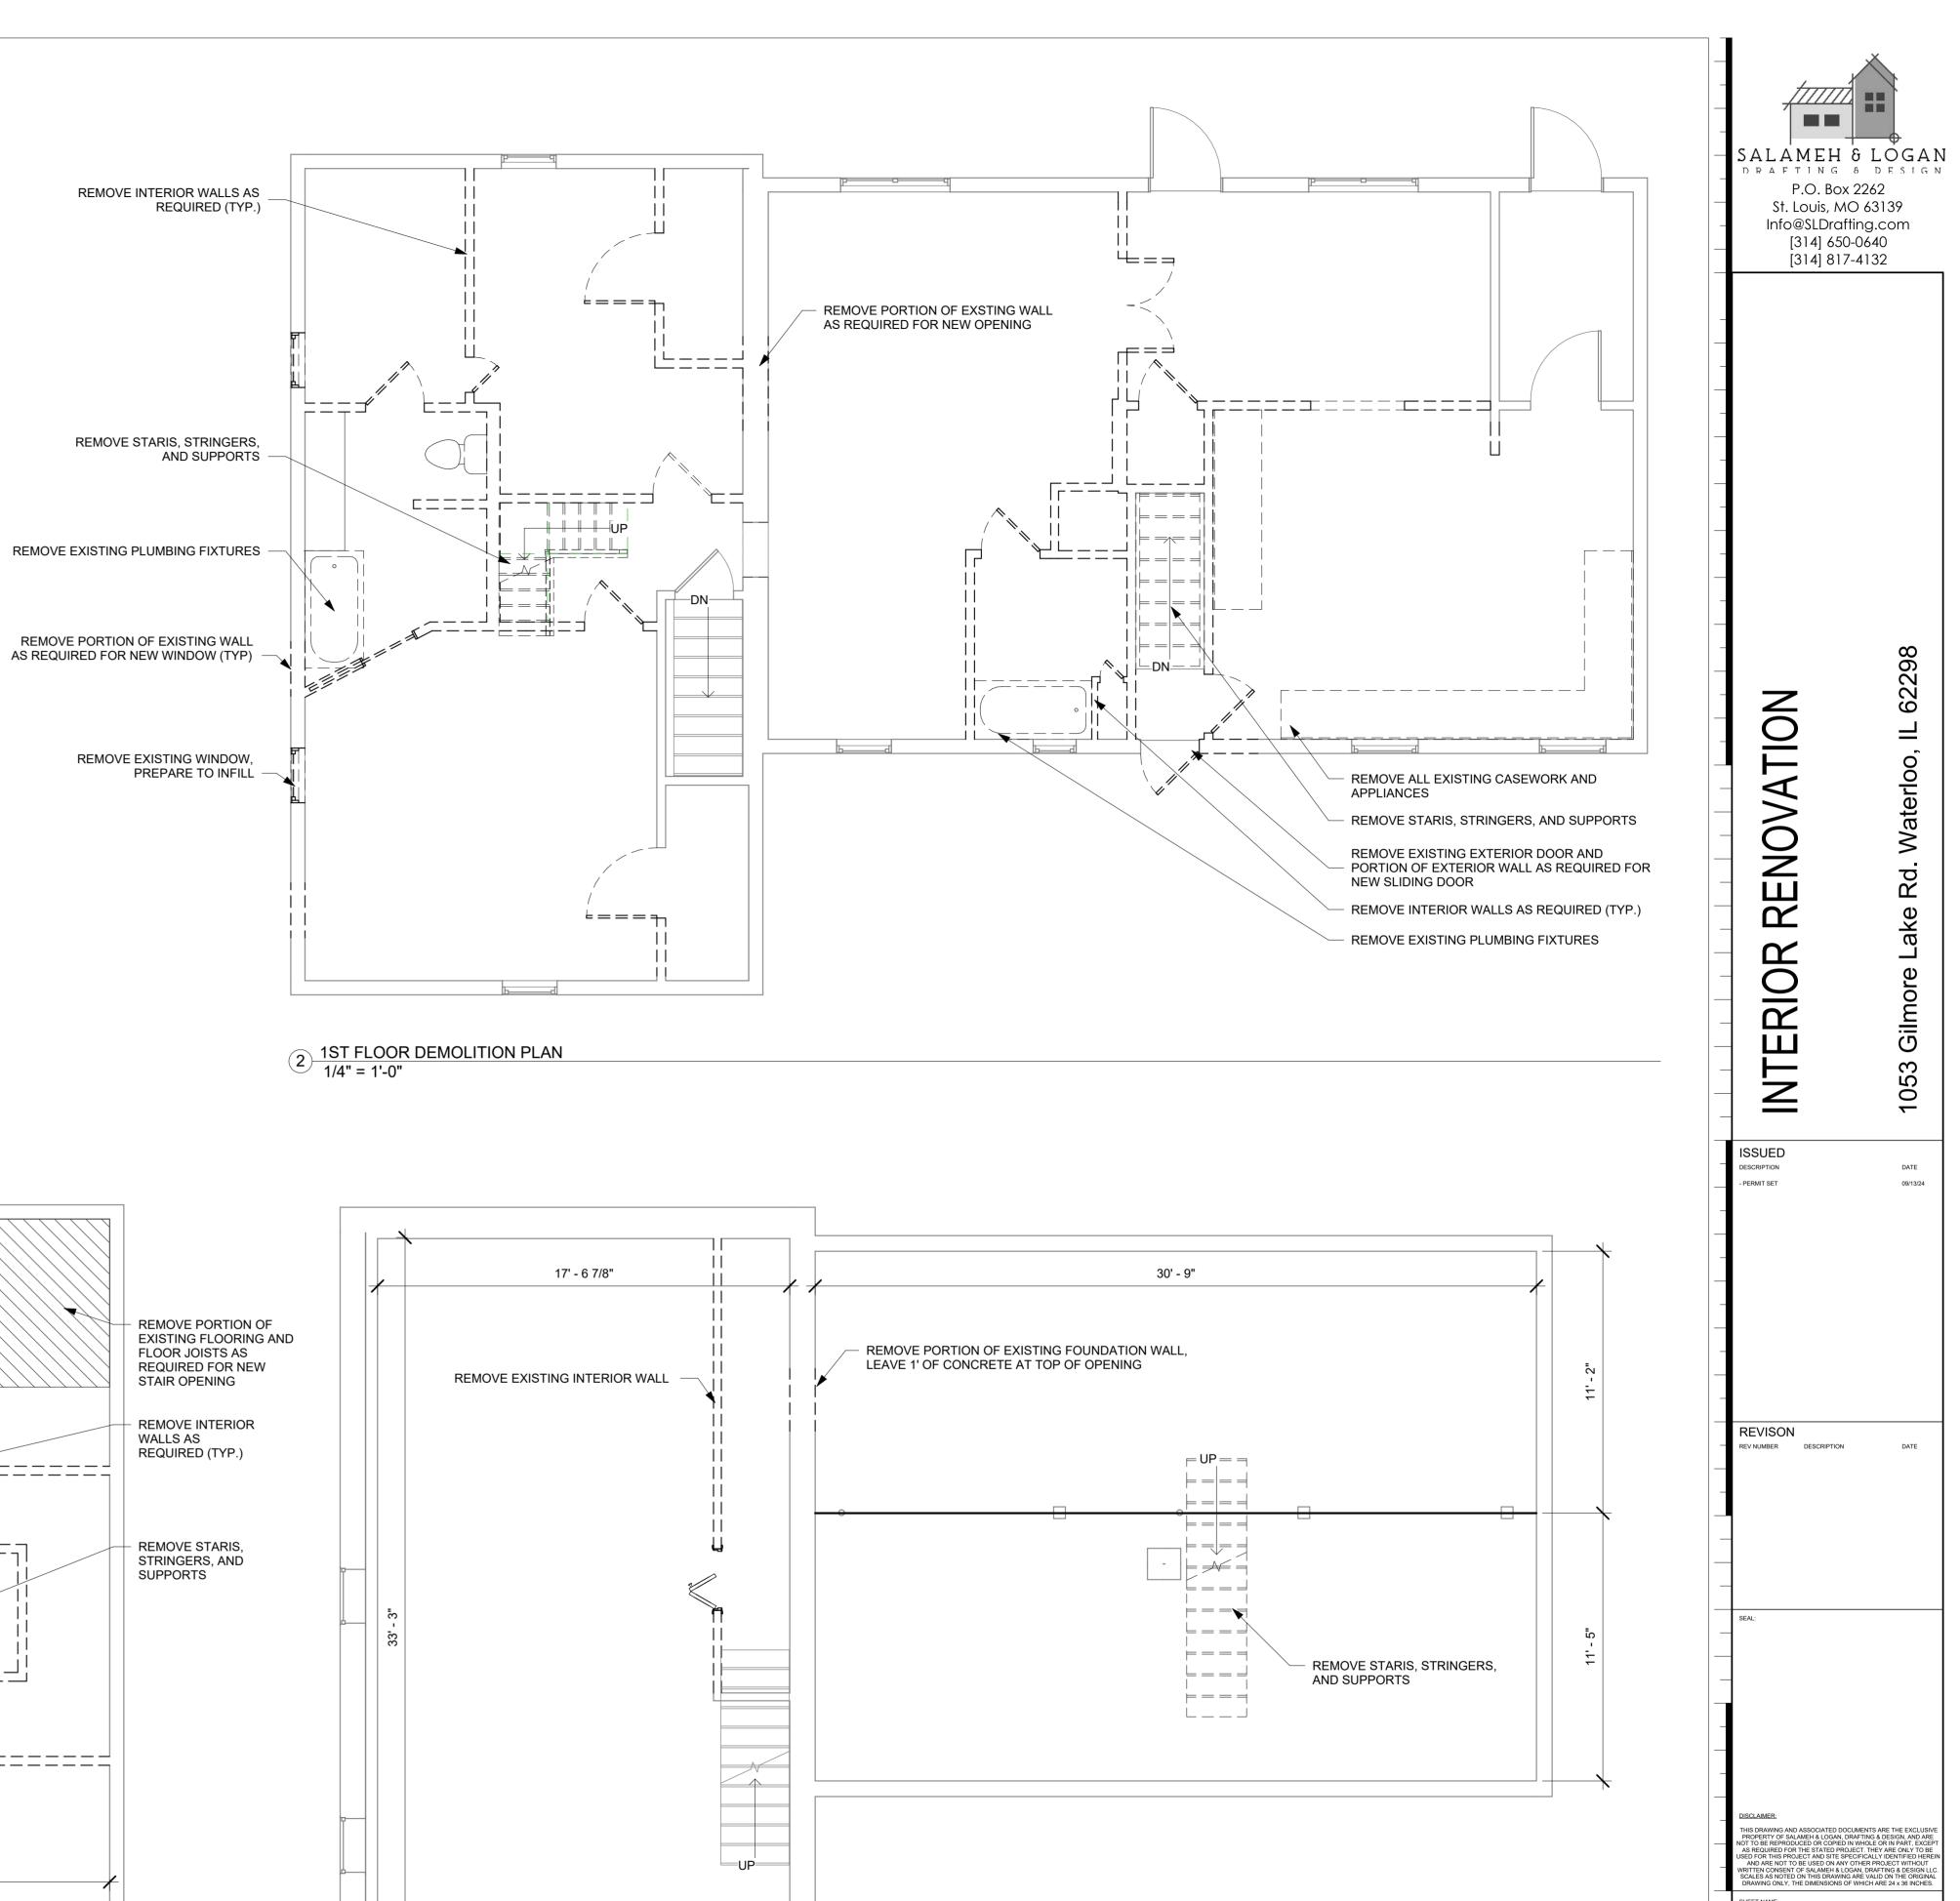


1 BASEMENT DEMOLITION PLAN 1/4" = 1'-0"


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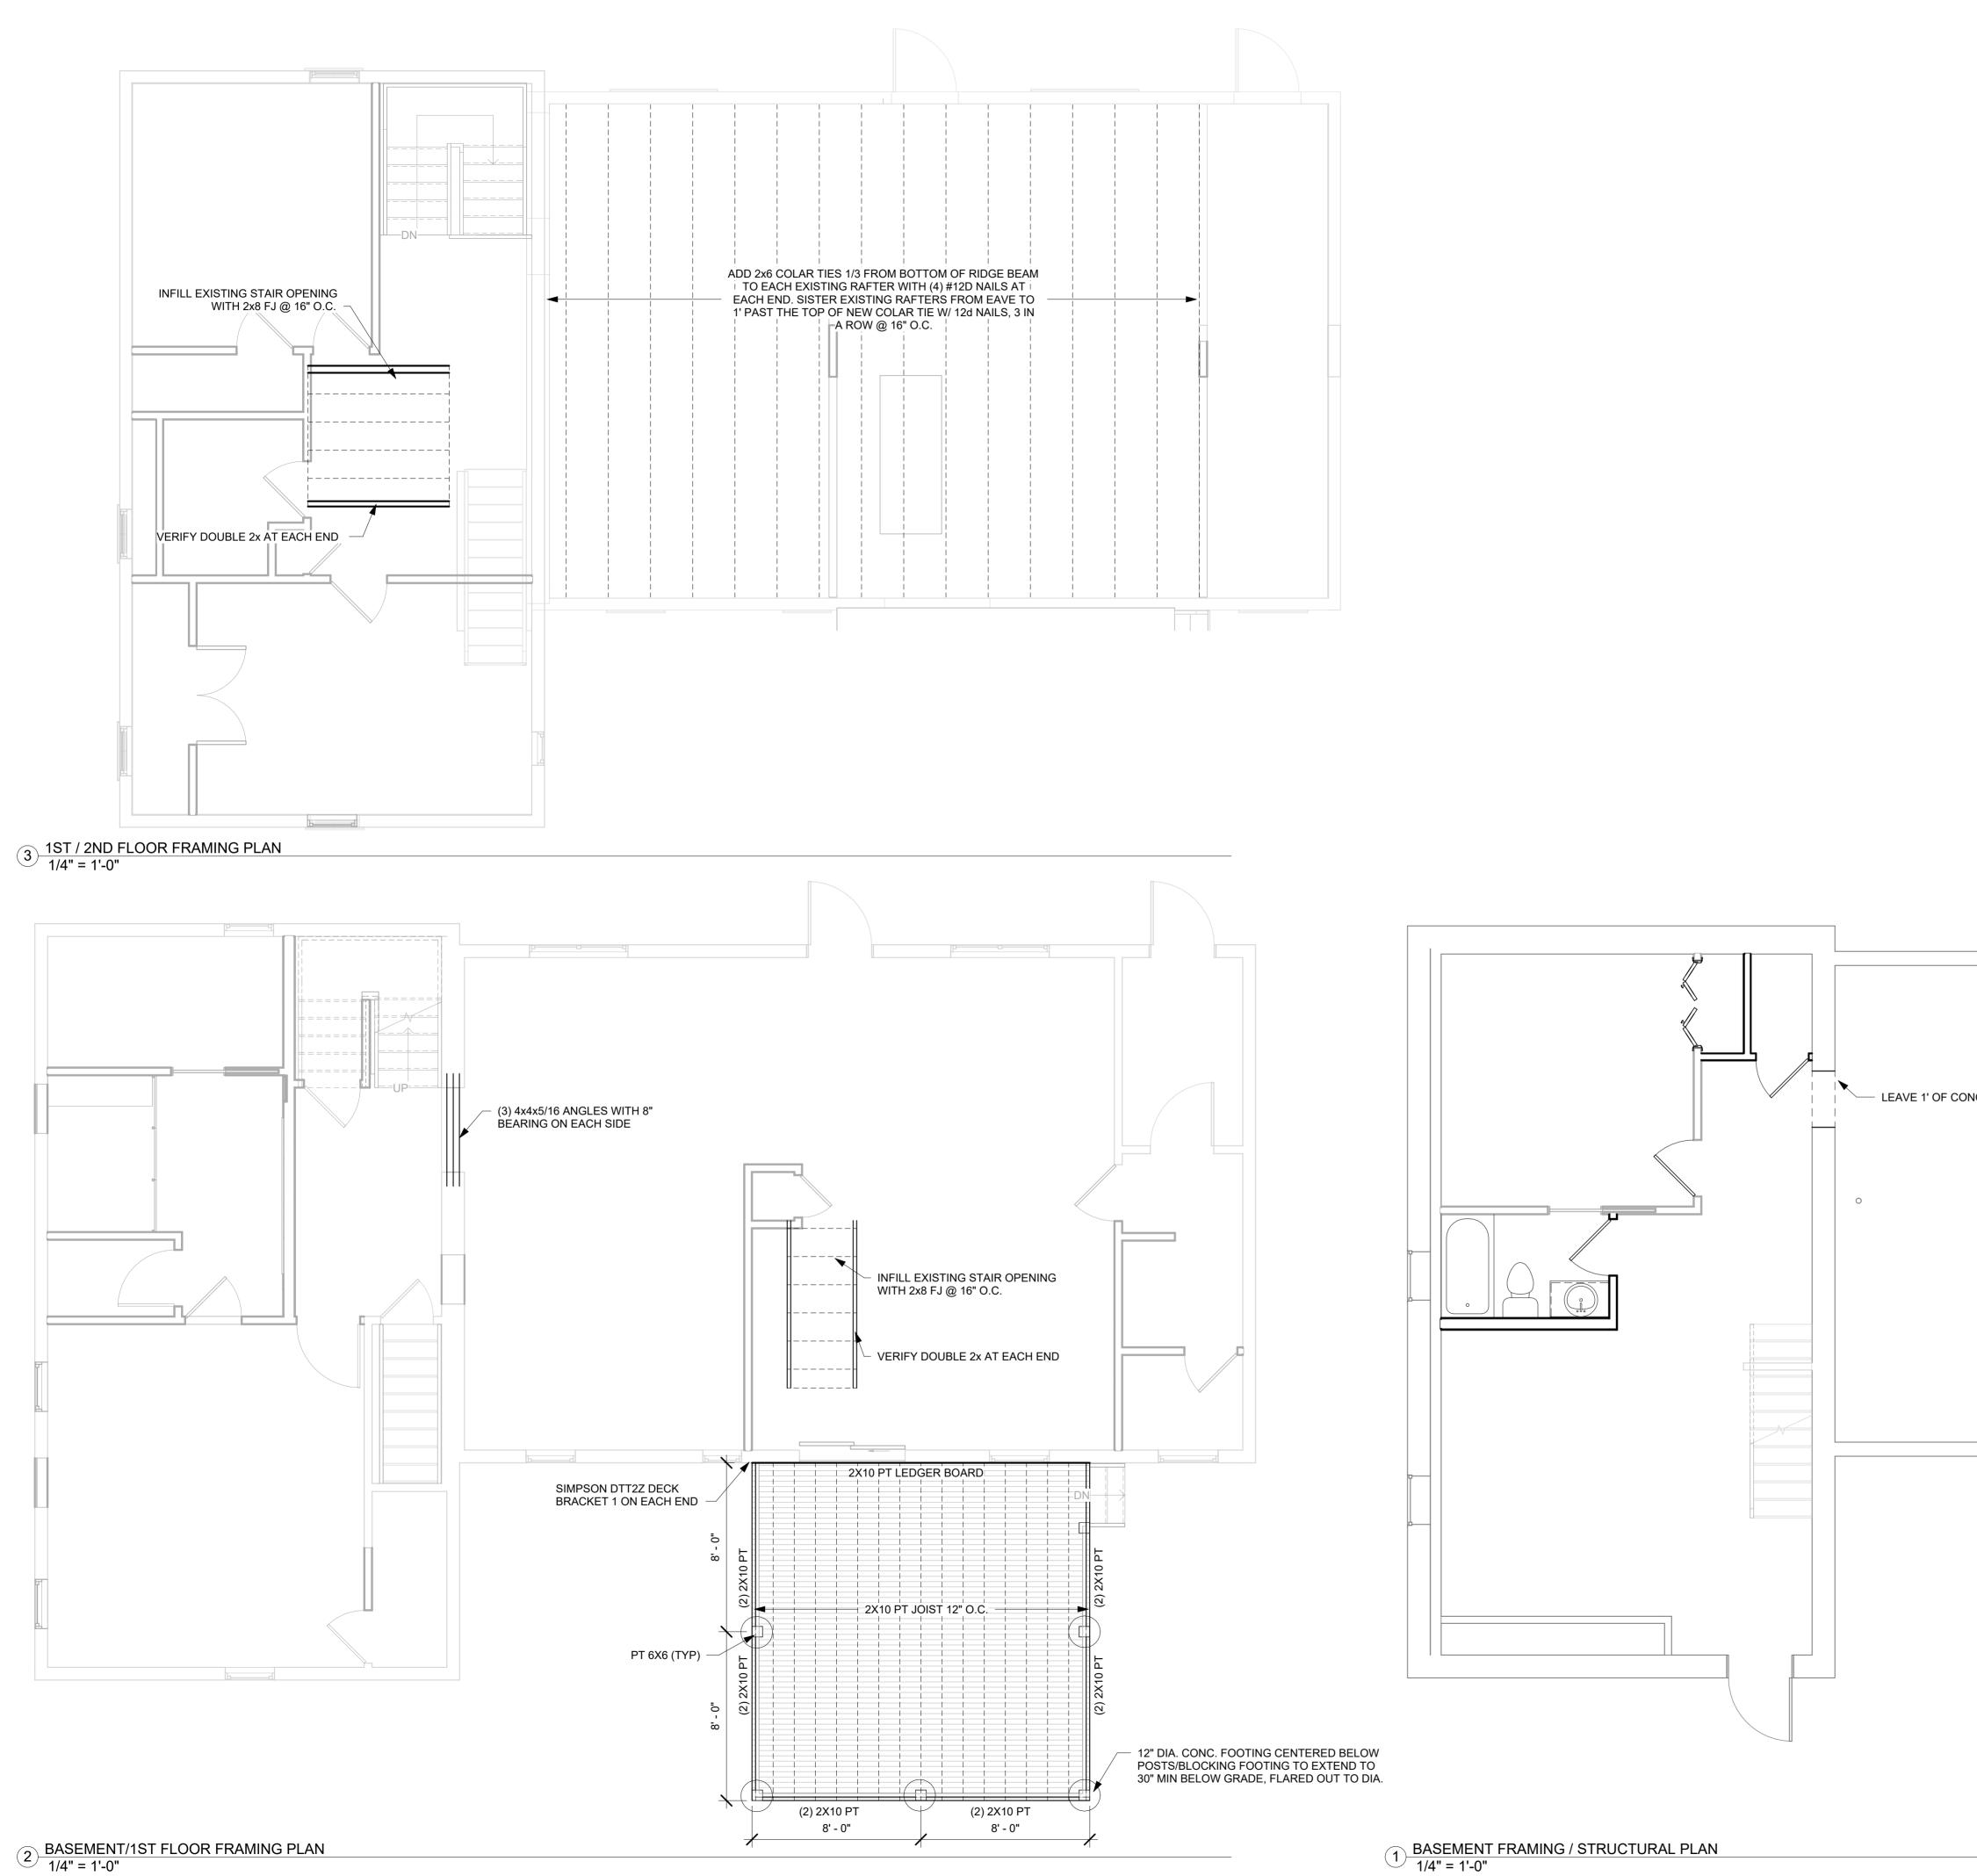


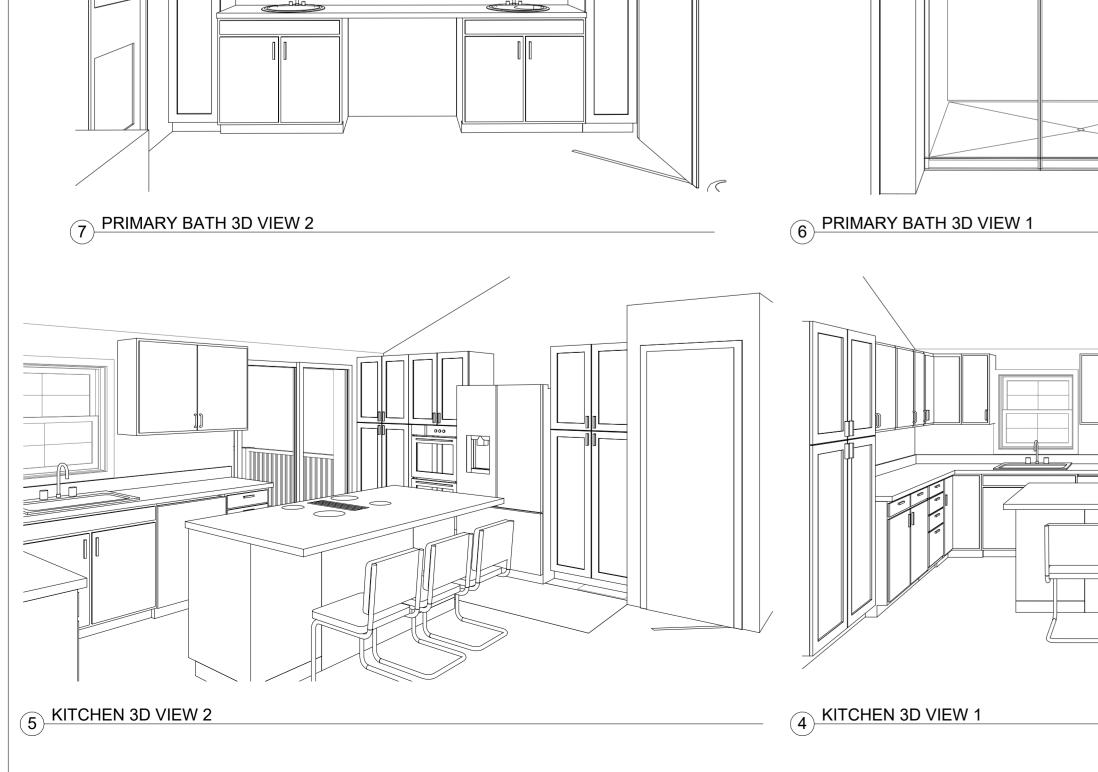

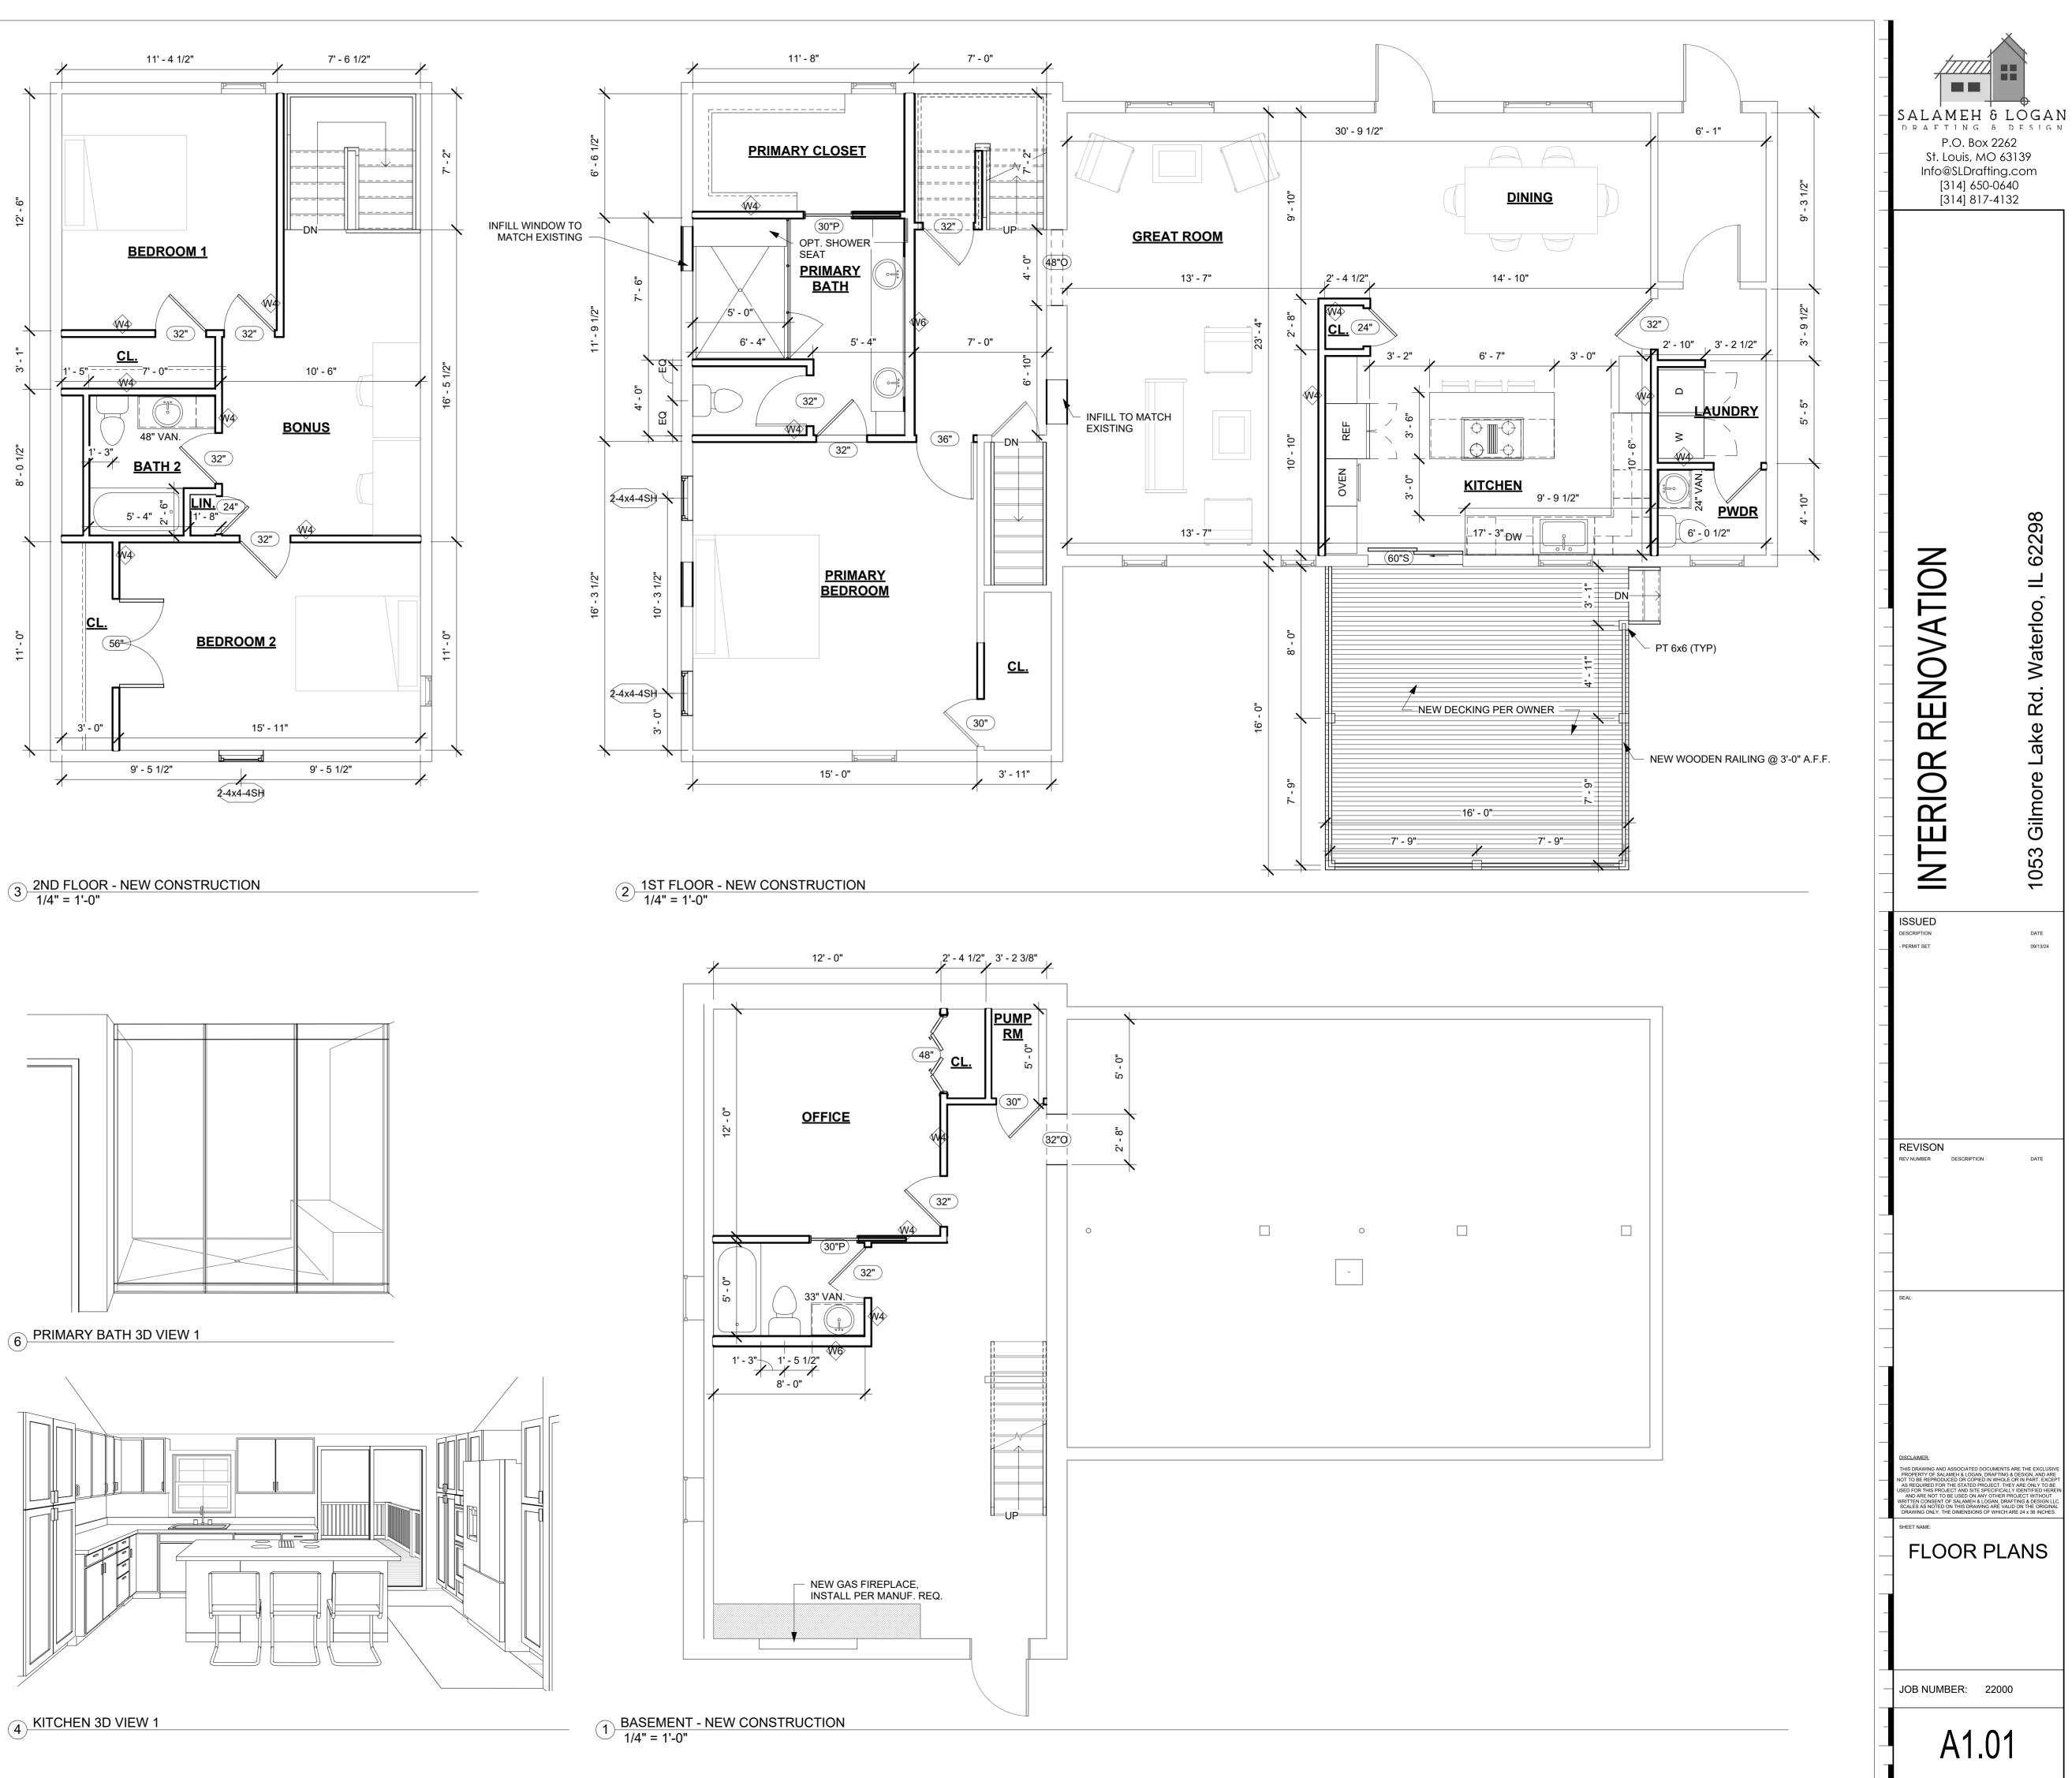



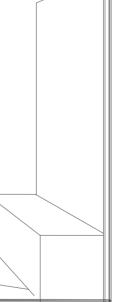

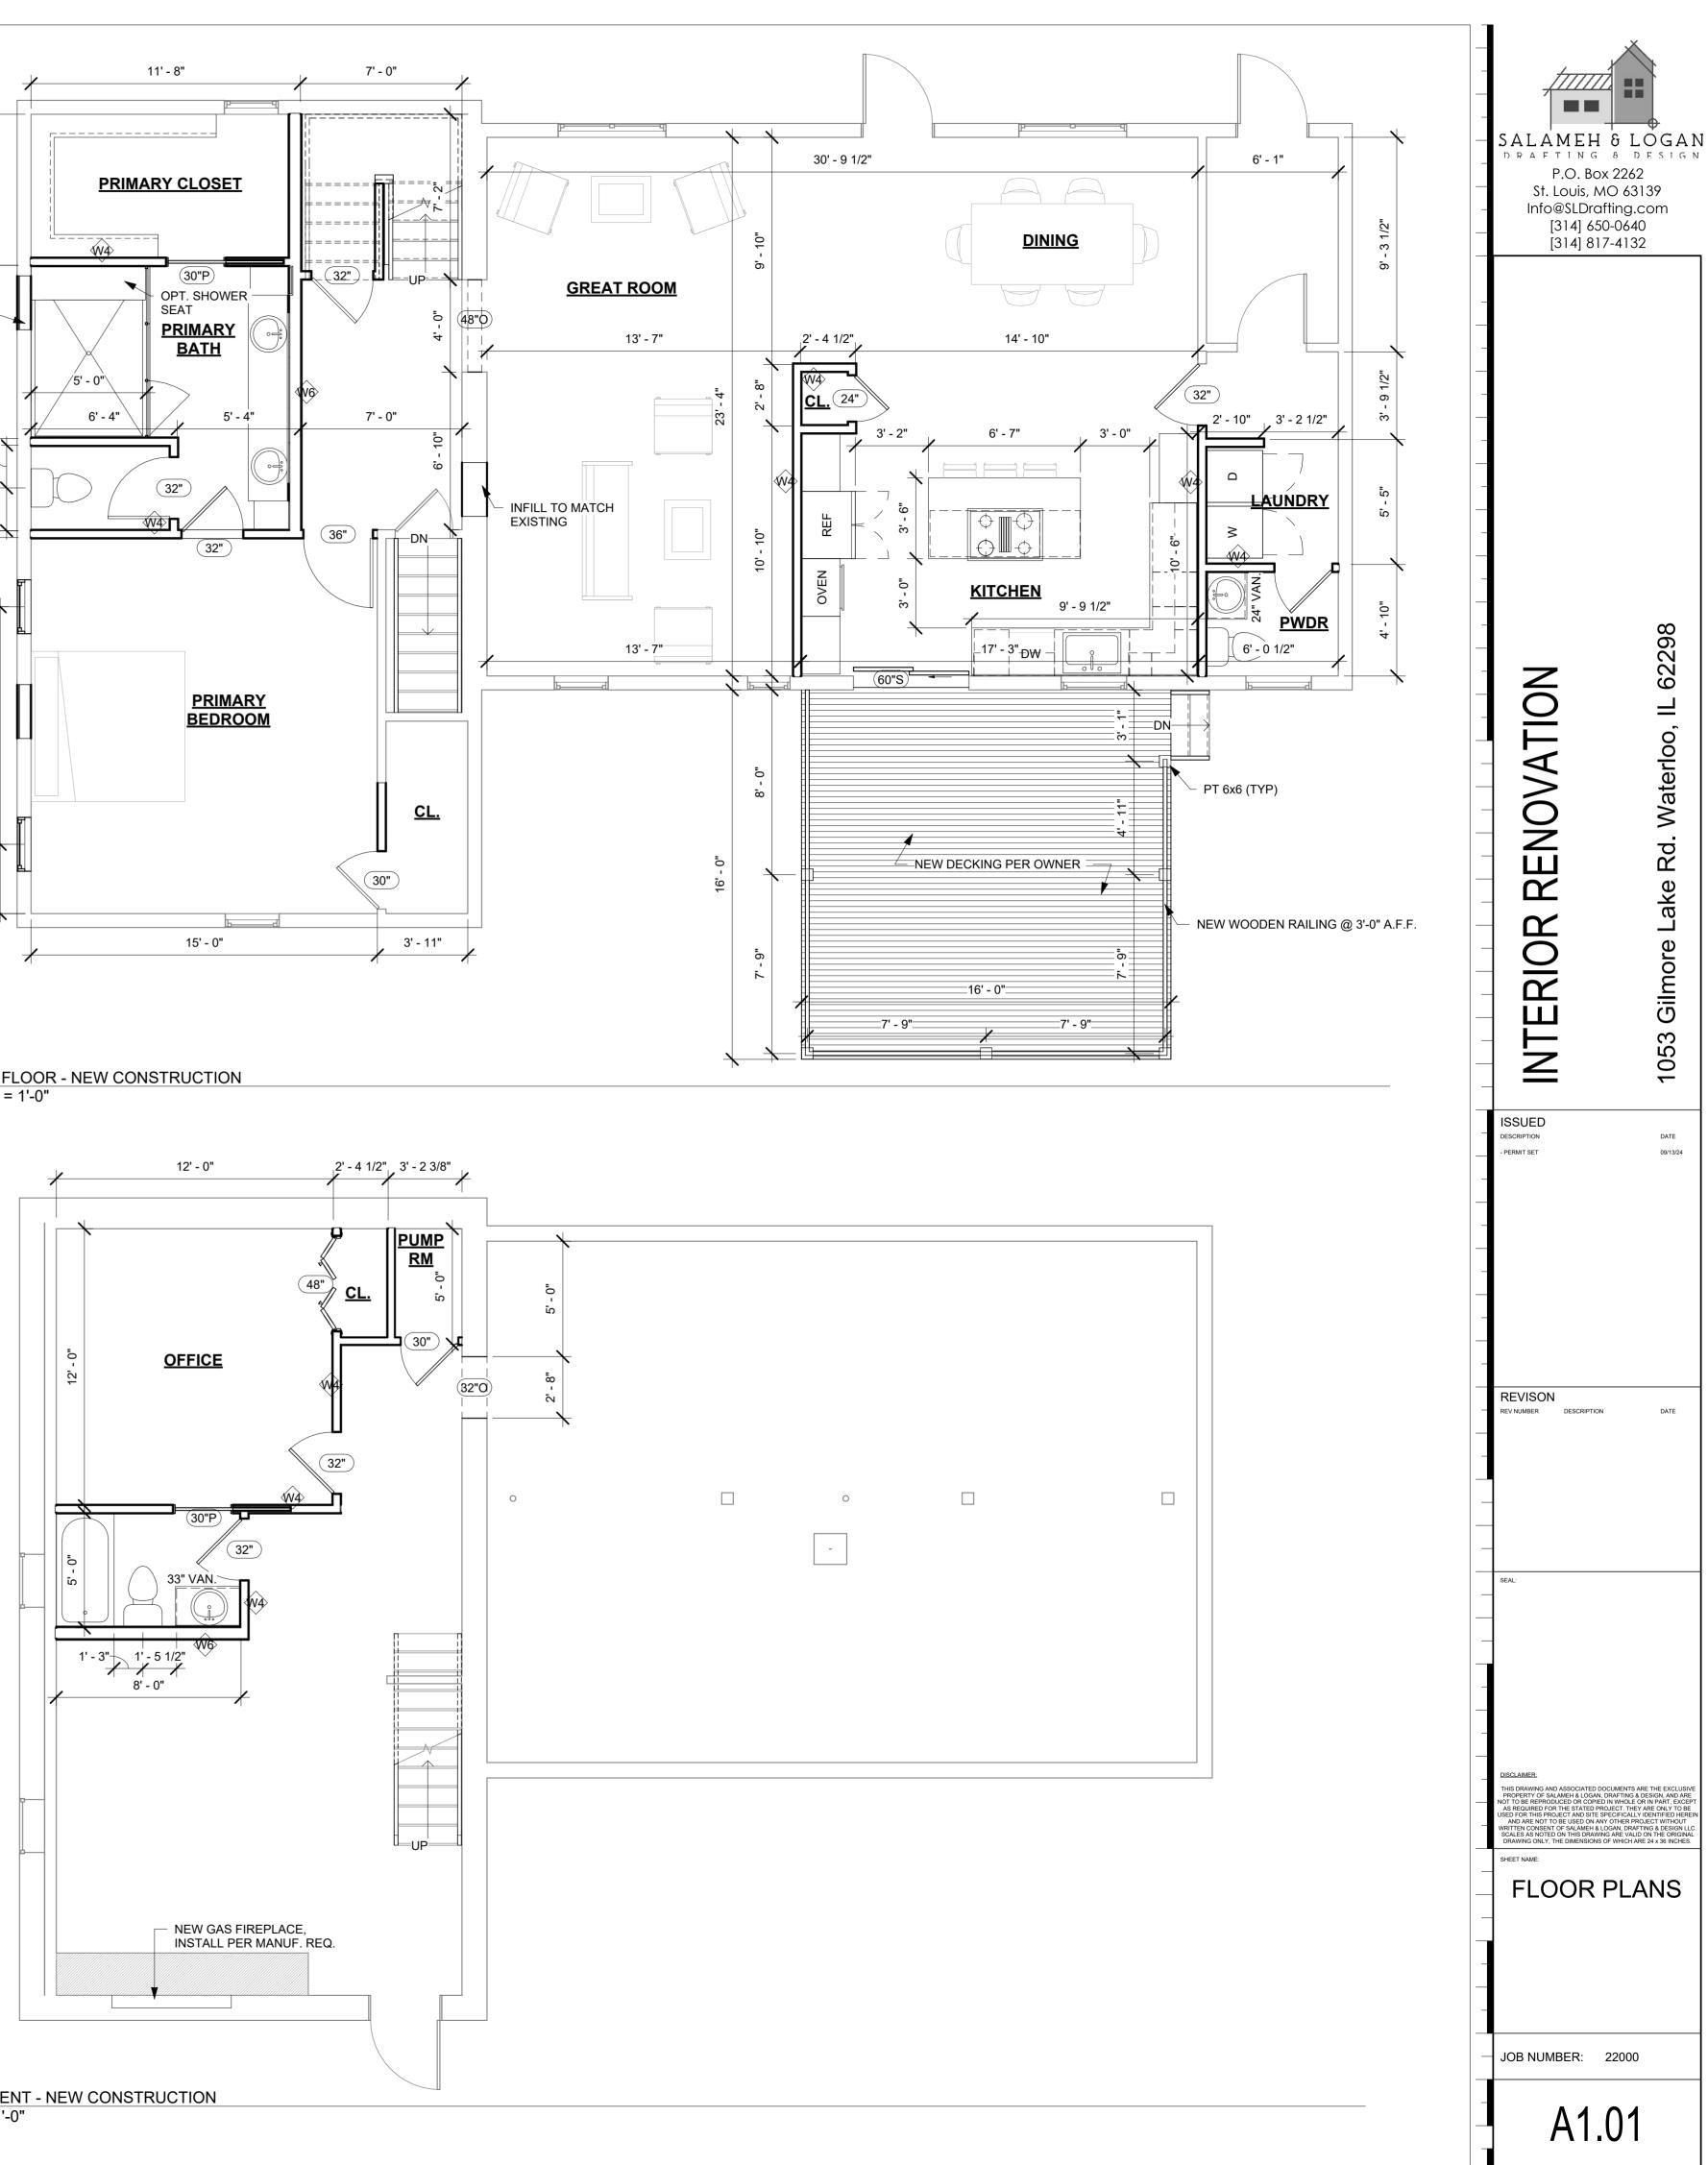




	SALAMEH δ LOGAN DRAFTING & DESIGN P.O. Box 2262 St. Louis, MO 63139 Info@SLDrafting.com [314] 650-0640 [314] 817-4132
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-	ISSUED DESCRIPTION DATE - PERMIT SET 09/13/24
-	REVISON Rev number description date
	SEAL:
	DISCLAIMER: THIS DRAWING AND ASSOCIATED DOCUMENTS ARE THE EXCLUSIVE PROPERTY OF SALAMEH & LOGAN, DRAFTING & DESIGN, AND ARE NOT TO BE REPRODUCED OR COPIED IN WHOLE OR IN PART, EXCEPT AS REQUIRED FOR THE STATED PROJECT. THEY ARE ONLY TO BE USED FOR THIS PROJECT AND SITE SPECIFICALLY IDENTIFIED HEREIN AND ARE NOT TO BE USED ON ANY OTHER PROJECT WITHOUT WRITTEN CONSENT OF SALAMEH & LOGAN, DRAFTING & DESIGN LLC. SCALES AS NOTED ON THE DRAVING REV VALID ON THE ORIGINAL DRAWING ONLY, THE DIMENSIONS OF WHICH ARE 24 x 36 INCHES.
	SHEET NAME: FRAMING PLANS
	JOB NUMBER: 22000
	A1.02


ICRETE ABOVE OPENING			
	-		
		NEW CONTINUOUS CARBON FIBER STRIP AND SOLDIER BEAMS AT 6' - 0" — O.C. ON EXISTING FOUNDATION WALL	

BUILDING INSULATION SCHEDULE


LOCATION/ASSEMBLY	R
ROOFS:	
INSULATION ENTIRELY ABOVE DECK ATTIC INSULATION	
WALLS:	
ABOVE GRADE, WOOD-FRAMED (EXT) ABOVE GRADE, MASS	R-20 (R
BELOW GRADE, BASEMENT	R
FLOORS:	
MASS	
WOOD FRAMING	
UNHEATED SLABS-ON-GRADE	R-10
DOORS:	
OPAQUE, SWINGING	
OPAQUE, ROLL-UP OR SLIDING	
FENESTRATION:	
STOREFRONT	
ENTRANCE DOOR	
ALL OTHERS (VINYL)	
EXTERIOR GLASS/METAL	




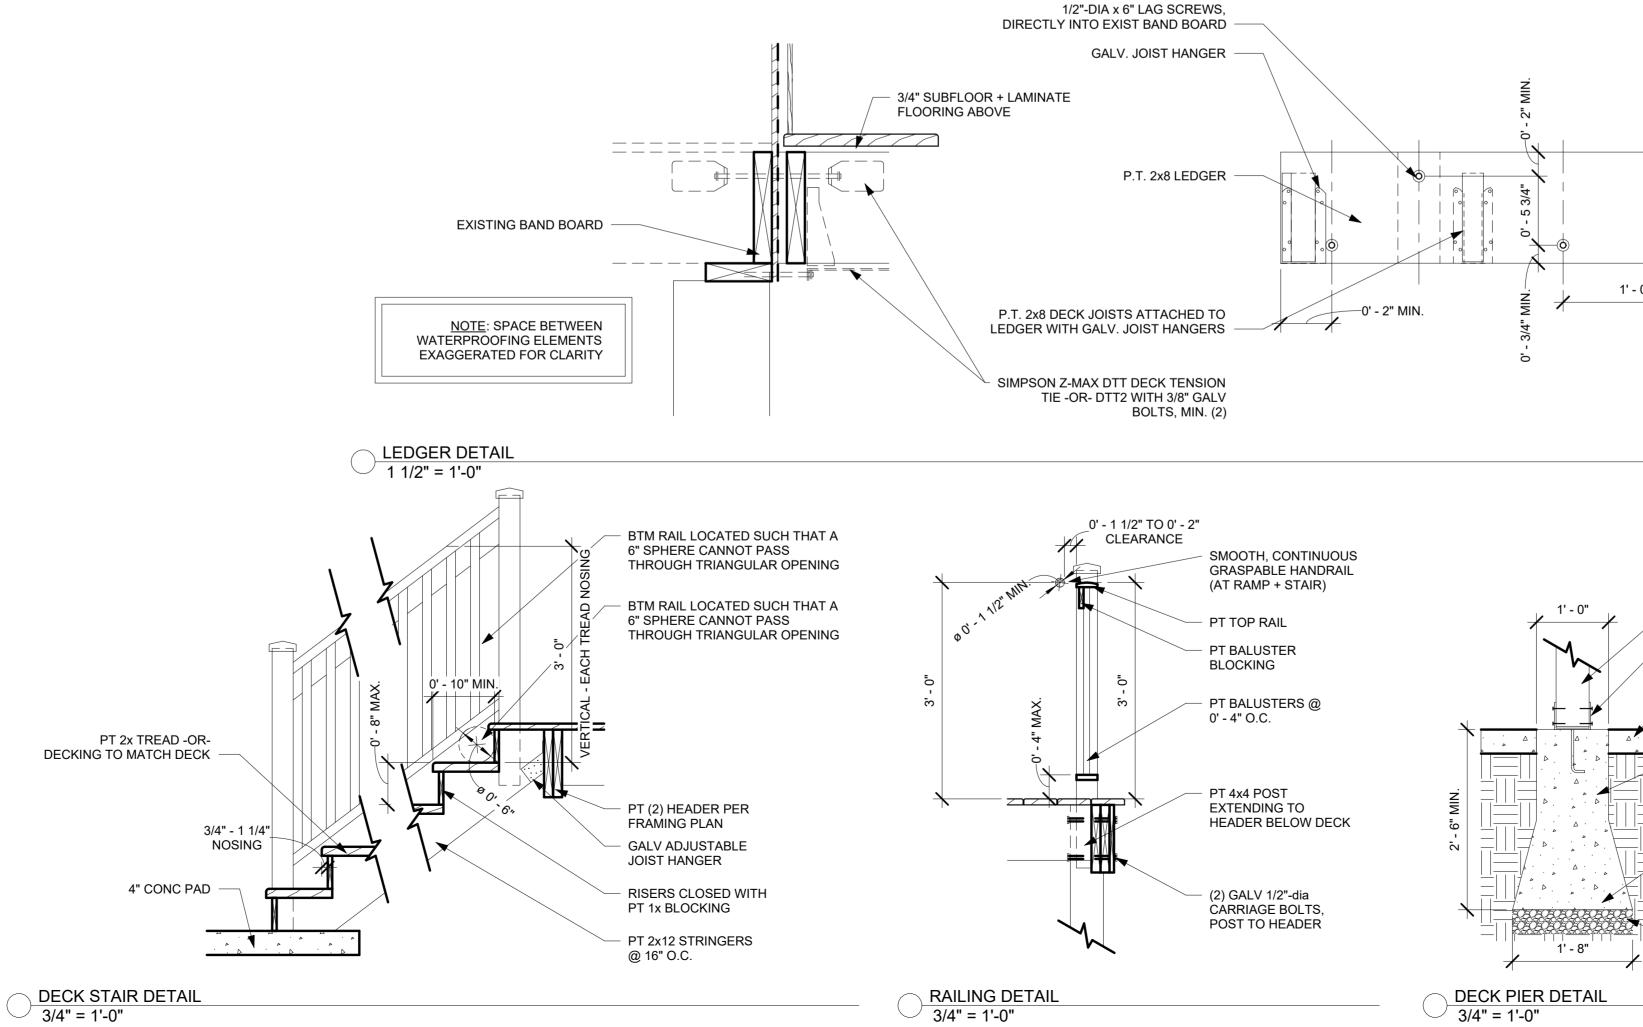

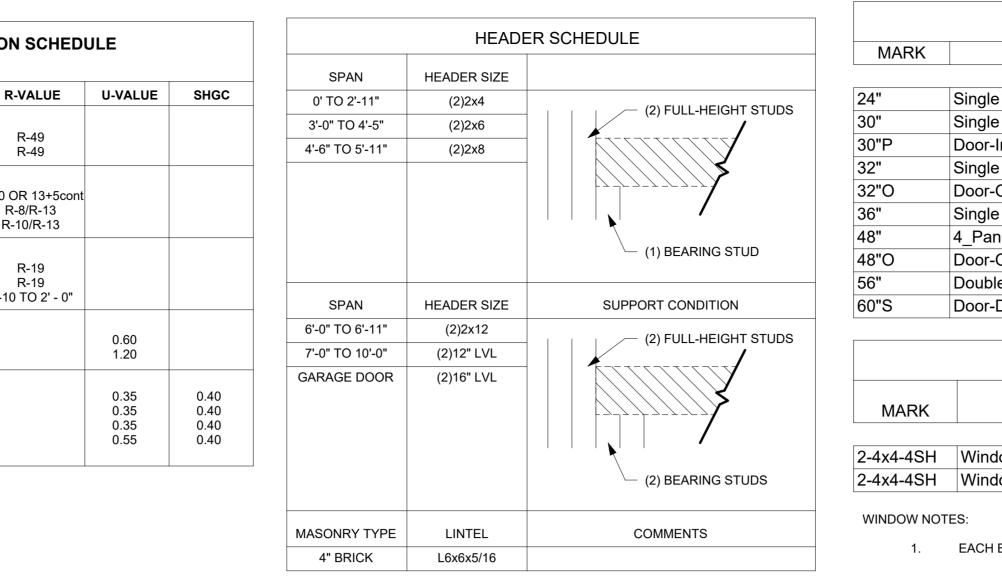


		DOOR	SCHEDULE							
ARK	TYPE			IGHT CO	JUNT	CO	MMENTS	-		OGAN
	Single Interior Doors Single Interior Doors	2' - 0' 2' - 6'	6' - 8	8" 3				-	P.O. Box 2262 St. Louis, MO 63	2 139 com
	Door-Interior-Single-Pocket-2_Panel-Wo Single Interior Doors	ood 2' - 6' 2' - 8'						-	[314] 650-064 [314] 817-413	0
)	Door-Opening Single Interior Doors	2' - 8' 3' - 0'	8" 6' - 8'	8" 1				-		
)	4_Panel_Bifold_Door_18619 Door-Opening	4' - 0' 4' - 0'						-	-	
	Double Interior Doors Door-Double-Sliding	4' - 8' 5' - 0'						-	-	
		W	/INDOW SCH						-	
IARK	TYPE	WIDTH	HEIGHT	SILL HEIGHT	LEVEL	COUN	COMMENTS		-	
4-4SH 4-4SH	0 0	2' - 4" 2' - 4"	4' - 4" 4' - 4"	2' - 1" 2' - 1"	Level 1 Level2	2 1			-	
1. 2. 3.	 EACH BEDROOM TO HAVE AT LEAST ONE (1) CA. NET CLEAR AREA OF NOT LESS B. NET CLEAR HEIGHT OF 24" MIN C. NET CLEAR WIDTH OF 20" MIN D. WINDOW SILL HEIGHT OF 3' - 6" ALL LIVING SPACES TO HAVE AT LEAST ONE (1) WINDOWS LOCATED IN 'HAZARDOUS LOCATIO A. ALL DOOR GLAZING B. WINDOWS IN WHICH A VERTICA OF THE GLAZING IS WITHIN 60" C. THE BOTTOM EDGE OF THE GLA D. WINDOWS INSIDE OF OR WITHIN E. WINDOWS ADJACENT TO STAIR F. WINDOWS LESS THAN 36" ABON G. SINGLE PANES OF GLASS MORE 	S THAN 5.7 sq ft \ AFF MAX) OPERABLE WI ONS' AS DEFINEI AL EDGE IS WITH OF FINISHED FI LAZING IS LESS IN 60" (MEASURI RS WITHIN 36" A VE THE BOTTOM	WHEN FULLY OF VINDOW OR DOO ED BY IRC R308.4 THIN 24" OF A DO FLOOR (EXCEPT THAN 1' - 6" AFF RED HORIZONTAI ABOVE STAIR SU M LANDING OF T	PEN (5.0 sq ft FC DR. 4 TO BE TEMPE DOR (HINGE-SID FOR DOORS TO LLY) OF A BATH JRFACE	OR WINDOWS A RED. LOCATION DE) IN THE CLOS O CLOSETS LES HTUB OR SHOW	NS INCLUDE: SED POSITIO SS THAN 36" I	VEL) N AND THE BOTTOM EDGE N DEPTH)		INTERIOR RENOVATION	1053 Gilmore Lake Rd. Waterloo, IL 62298
	NIN. 2" MIN.			2. PROVIDE C ACOUSTIC INSULATION STUD CAVI PARTITION	BEARING SHOWN. STRUCTURAL SFOR LOAD STUD INFO. CONT. BATT N IN THE TY AT S WITH AN "A" ION . SEAL ALL IONS AND TION OR FIRE ION WOOD STUD D. NA NA		2X6 WOOD O.C. (1) LAYER 1 EACH SIDE 2X6 WOOD 2X6 WOOD PARTITION TYPE ED 6" NOM. WOOD STUD	FRAMING	SEAL:	DATE 09/13/24
ECK	$1^{-0^{\circ}}$	 PT 6x6 GALV POST B SIMPSON ABL OR SIMILAR 4" CONC. SLA CONCRETE P 1' - 0"-dia AT T CONCRETE P 1' - 8"-dia AT B 4"-DEEP GRAM BASE 	U-66Z AB PIER - TOP - BASE -	 NON-LOAD PARTITION REFER TO STRUCTUR DRAWINGS BEARING S PROVIDE C ACOUSTIC INSULATION STUD CAVI PARTITION "A" DESIGN SEAL ALL PENETRATI VOIDS. REFER TO SPECIFICA SECTION FO STOPPING INFORMATI CORE TYPE UL DESIGN NC FIRE RATING 	I SHOWN. RAL S FOR LOAD STUD INFO. CONT. BATT N IN THE ITY AT IS WITH AN IATION . TIONS AND TION SOR FIRE	PLAN	-4 1/2" 2X4 WOOD S 0.C. (1) LAYER 1/2 EACH SIDE 2X4 WOOD F	2" GWB,	DISCLAIMER: THIS DRAWING AND ASSOCIATED DOCUMENTS A PROPERTY OF SALAMEH & LOGAN, DRAFTING & NOT TO BE REPRODUCED OR COPIED IN WHOLE OF SAS REQUIRED FOR THE STATED PROJECT. THE USED FOR THIS PROJECT AND SITE SPECIFICALLY AND ARE NOT TO BE USED ON ANY OTHER PR WRITTER CONSENT OF SALAMEH & LOGAN, DRAF SCALES AS NOTED ON THIS DRAWING ARE VALI DRAWING ONLY, THE DIMENSIONS OF WHICH AN SHEET NAME: SCHEED NAME: JOB NUMBER: 220000	DESIGN, AND ARE DESIGN, AND ARE YARE ONLY TO BE YARE ONLY TO BE THOS A DESIGN LLC. DO NTHE ORIGINAL RE 24 x 36 INCHES. THE ONLY AND ARE S
	DECK PIER DETAIL 3/4" = 1'-0"		ł	W4	INTER		TITION TYPE NOM. WOOD STUD PART	ITION	A3.01	
			L				• •			

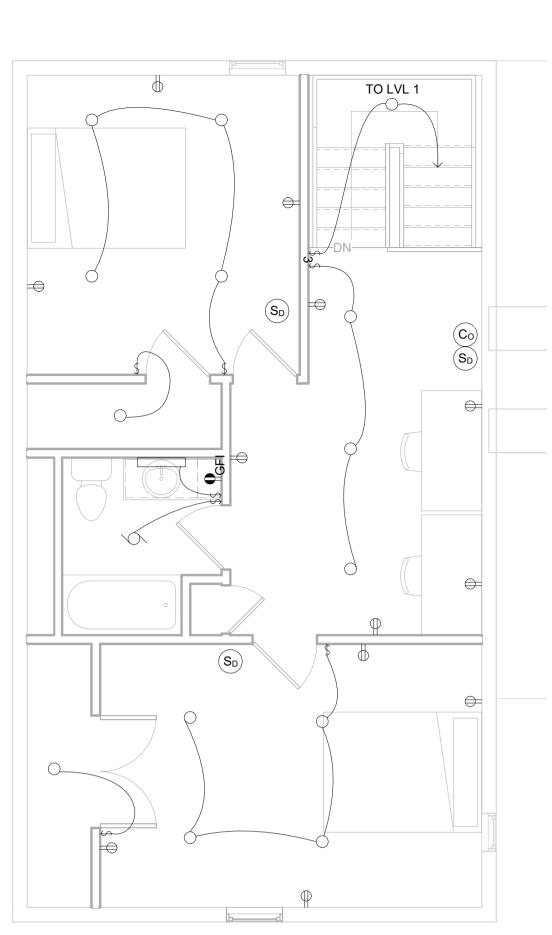

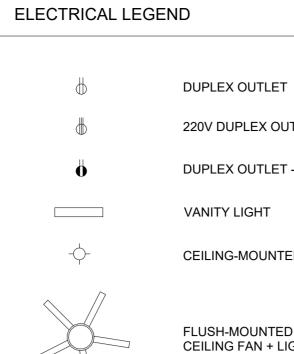

3 2ND FLOOR REFLECTED CEILING & ELECTRICAL PLAN 1/4" = 1'-0"

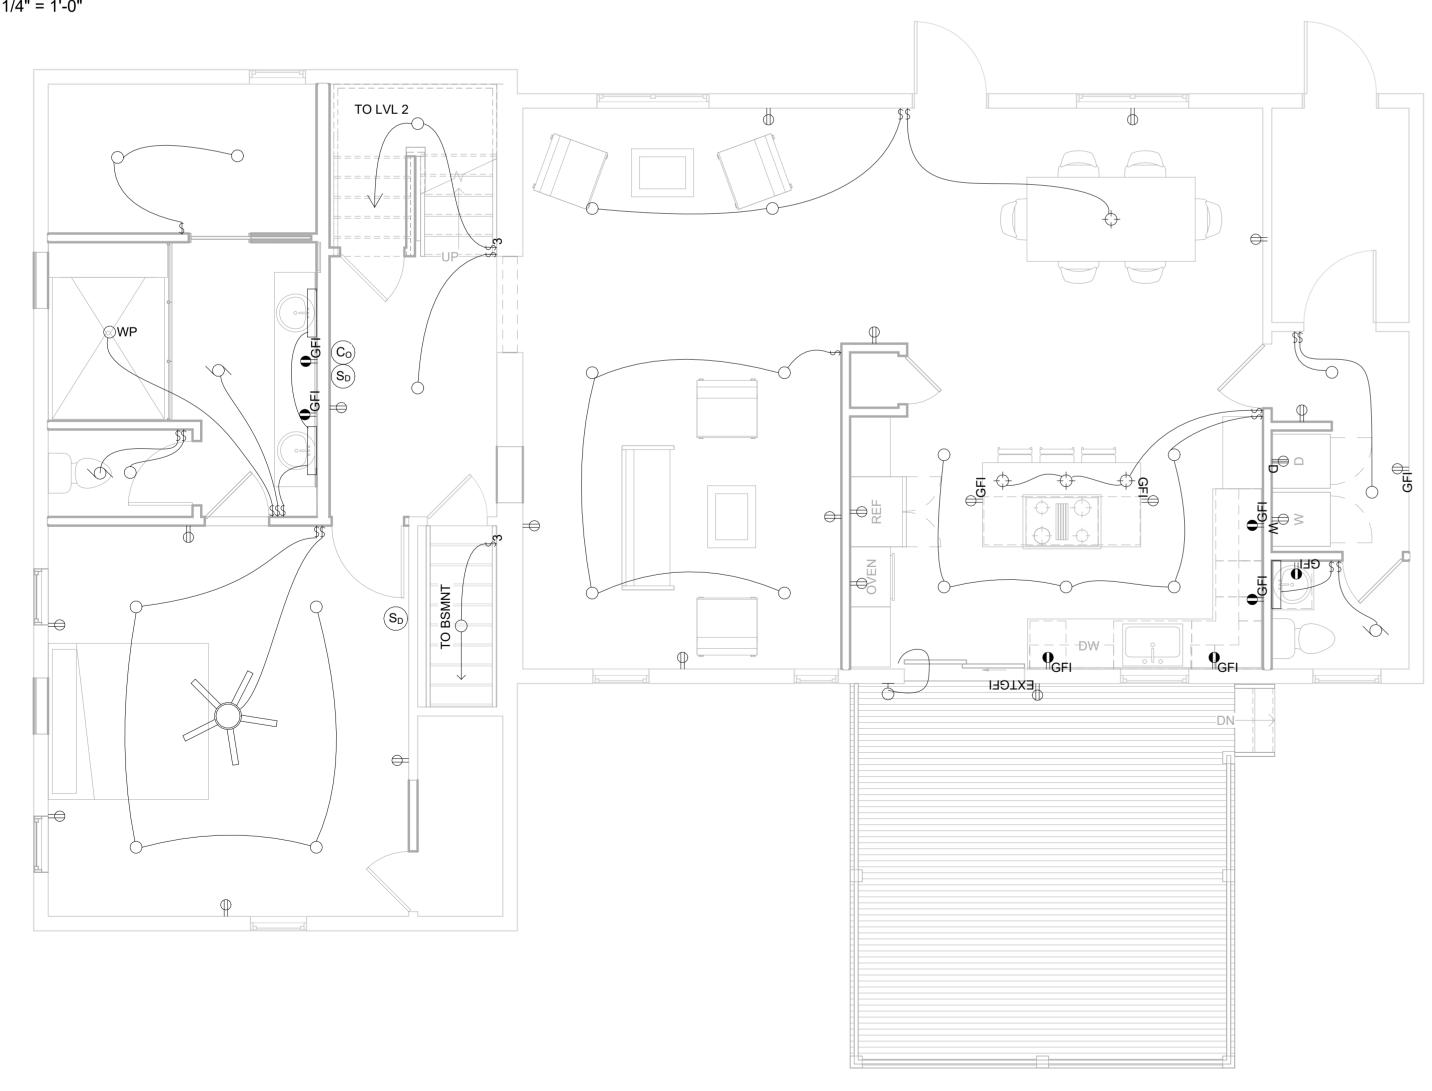

2 1ST FLOOR REFLECTED CEILING & ELECTRICAL PLAN 1/4" = 1'-0"

			ELEC	TRICAL NOTES		
	X		1	ALL WIRING + ELECTRICAL RECEPTACLES (SHOWN AND	6.	ALL OL
_ 1	Q	CEILING-MOUNTED JUNCTION BOX	1.	NOT SHOWN) TO GROUNDED (3-PRONG).	0.	(INCLU OUTLE
DUTLET	0	RECESSED CAN LIGHT FIXTURE	2.	EACH BATHROOM TO HAVE AT LEAST ONE (1) GROUND- FAULT CIRCUIT INTERRUPTOR (GFI) OUTLET AT COUNTER		A WATI
ET - COUNTER-HEIGHT	\Leftrightarrow	CEILING-MOUNTED PENDANT FIXTURE		HEIGHT.	7.	ALL 15- ARC-FA
	<u> </u>	WALL SCONCE MOUNTED @ 6' - 8" A.F.F.	3.	KITCHEN OUTLETS TO BE SPACED PER DIAGRAM BELOW. ALL OUTLETS AT COUNTER HEIGHT TO BE GFI. NO	8.	WIRED
		UNDERCABINET LIGHT (KITCHEN)		COUNTER SPACE TO BE MORE THAN 2' - 0" FROM AN OUTLET.		DETEC
ITED FIXTURE	\mathbf{N}	EXHAUST FAN	4.	KITCHEN ISLANDS AND PENINSULA TO HAVE AN ELECTRICAL OUTLET, LOCATED WITHIN 1' - 8" OF COUNTER.		EACH (VERIF) MONO OWNEI
ED LIGHT	Co	CEILING-MOUNTED CARBON MONOXIDE DETECTOR	5.	OUTLETS IN ALL OTHER PRIMARY 'LIVING' AREAS (LIVING ROOM, DINING, BEDROOMS, ETC) TO BE SPACED SUCH THAT NO POINT ON ANY WALL TO BE MORE THAN 6' - 0"		
	SD	CEILING-MOUNTED HARD-WIRED SMOKE DETECTOR		FROM AN OUTLET.		

